

## PUBLIC IMPROVEMENTS

## N HUMBOLDT ST WEST OF N GAY AVE

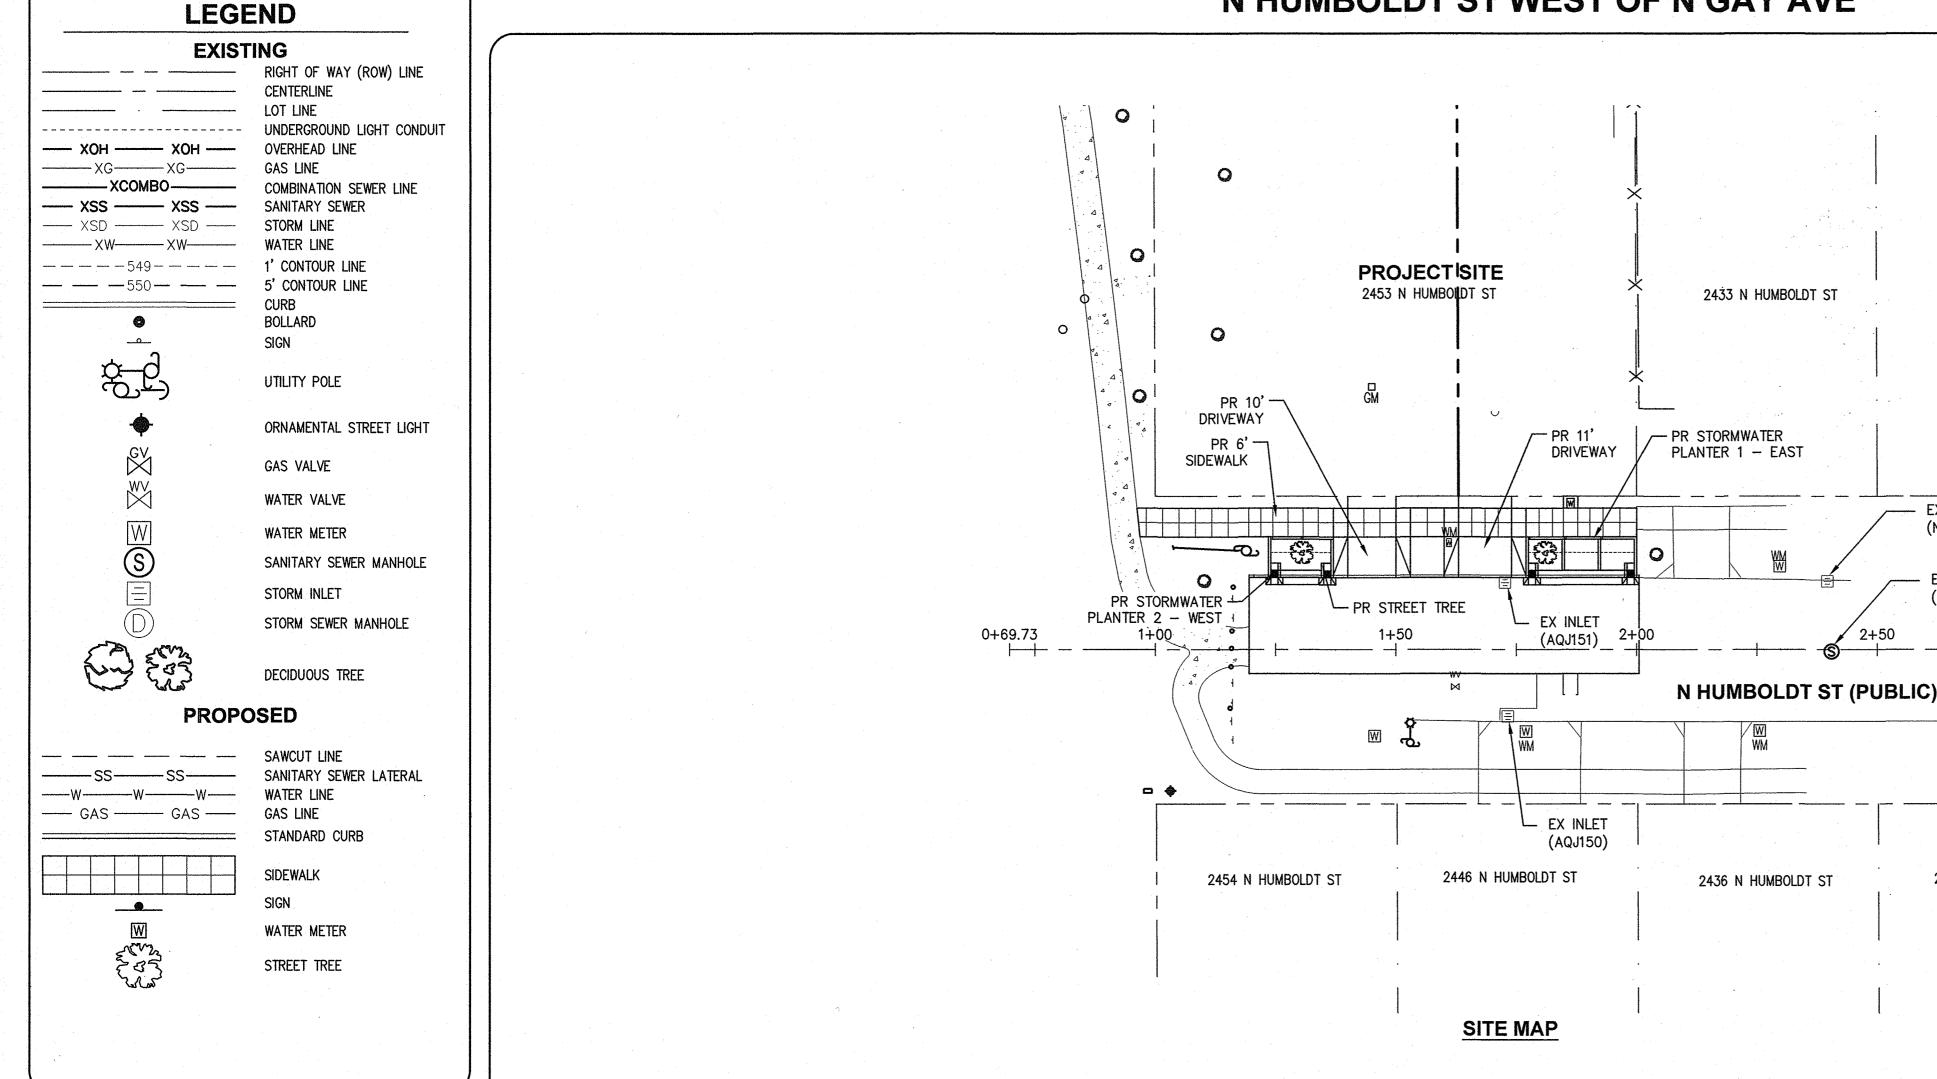

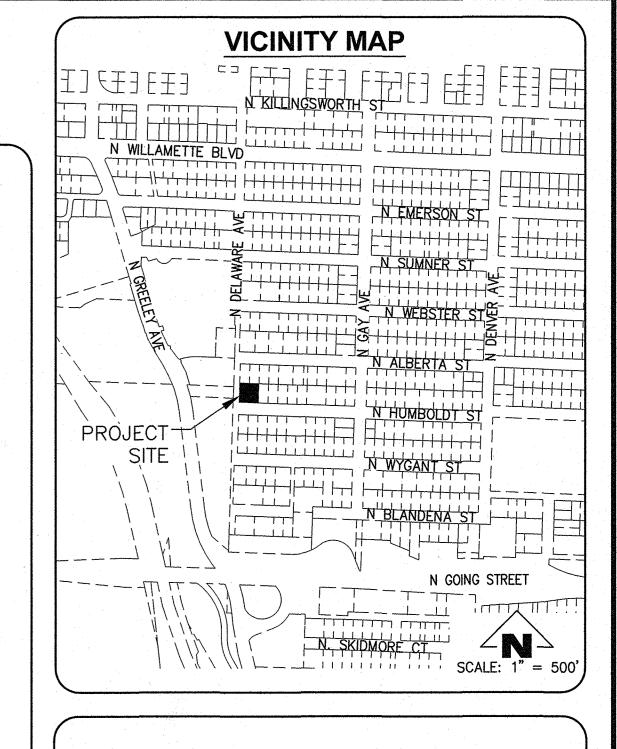

## **DRAWING INDEX**

- COVER SHEET
- NOTES AND TYPICAL SECTIONS
- EXISTING CONDITIONS AND DEMOLITION PLAN
- N HUMBOLDT ST PLAN AND PROFILE
- N HUMBOLDT ST GRADING PLAN
- STORMWATER FACILITY PLAN
- INLET AND PLANTER DETAILS
- STANDARD DETAILS
- STANDARD DETAILS EROSION CONTROL PLAN

#### ATTENTION: OREGON LAW REQUIRES YOU TO FOLLOW RULES ADOPTED BY THE **STORMWATER NARRATIVE** OREGON UTILITY NOTIFICATION CENTER.

#### **PUBLIC**

INFILTRATION PLANTERS ARE PROPOSED TO TREAT AND DETAIN 1,710 SF OF DEVELOPED IMPERVIOUS AREA. STORMWATER COLLECTED ON N HUMBOLDT ST WILL BE TREATED AND DETAINED IN 3 PUBLIC STORMWATER FACILITIES. ANY OVERFLOW FROM FACILITIES WILL FLOW INTO EXISTING INLET AQJ151 IN THE COMBINED SEWER SYSTEM ON N HUMBOLDT ST OR FLOW WEST TOWARDS MADRONA CITY PARK.

#### PRIVATE

BASED THE INFILTRATION TESTING RESULTS, THE ONSITE STORMWATER DISCHARGE WILL OCCUR IN ON-SITE DRYWELLS

## **ENGINEER'S NOTE TO CONTRACTOR**

THE EXISTENCE AND LOCATION OF ANY UNDERGROUND UTILITIES OR STRUCTURES SHOWN ON THESE PLANS ARE OBTAINED BY A SEARCH OF AVAILABLE RECORDS. TO THE BEST OF OUR KNOWLEDGE, THERE ARE NO EXISTING UTILITIES EXCEPT THOSE SHOWN ON THESE PLANS. THE CONTRACTOR IS REQUIRED TO TAKE DUE PRECAUTIONARY MEASURES TO PROTECT THE UTILITY LINES SHOWN ON THESE DRAWINGS. THE CONTRACTOR FURTHER ASSUMES ALL LIABILITY AND RESPONSIBILITY FOR THE UTILITY PIPES, CONDUITS OR STRUCTURES SHOWN OR NOT SHOWN ON THESE DRAWINGS.

THE CONTRACTOR AGREES THAT HE SHALL ASSUME SOLE AND COMPLETE RESPONSIBILITY FOR THE JOB SITE CONDITIONS DURING THE COURSE OF CONSTRUCTION OF THIS PROJECT, INCLUDING SAFETY OF ALL PERSONS AND PROPERTY; THAT THIS SHALL APPLY CONTINUOUSLY AND NOT BE LIMITED TO NORMAL WORKING HOURS; AND THAT THE CONTRACTOR SHALL DEFEND, INDEMNIFY AND HOLD THE OWNER AND THE ENGINEER HARMLESS FROM ANY AND ALL LIABILITY, REAL OR ALLEGED, IN CONNECTION WITH THE PERFORMANCE OF WORK ON THIS PROJECT, EXCEPT FOR LIABILITY ARISING FROM THE SOLE NEGLIGENCE OF THE OWNER OR THE ENGINEER.

CONTRACTOR SHALL VERIFY ALL CONDITIONS AND DIMENSIONS AND SHALL REPORT ANY DISCREPANCIES TO THE ENGINEER PRIOR TO THE COMMENCEMENT

#### **PROJECT CONTACTS**

#### APPLICANT:

YVES LABISSIERE 2453 N HUMBOLDT ST PORTLAND, OR 97217 503-358-3568 E-MAIL: LABISSY@GMAIL.COM **CIVIL ENGINEER:** EMERIO DESIGN, LLC 6445 SW FALLBROOK PL BEAVERTON, OR 97008 (503) 639-9592 (F) CONTACT: STEVE HANSEN, P.E.

(503) 746-8812 (P)

RT - RIGHT

2424 N HUMBOLDT ST

2423 N HUMBOLDT ST

EX INLET (NO ID)

- EX CSMH

(AAQ180)

ZTEC ENGINEERS INC. 3880 S.E. 8TH AVE., SUITE 280 PORTLAND, OR. 97202 CONTACT: CHRIS FISCHBORN P: 503-235-8795

ELEV - ELEVATION

**SURVEYOR:** 

F: 503-233-7889

BPZ - BACK OF PEDESTRIAN ZONE ELEVATION

- DEPRESSED GUTTER ELEVATION

- DRAINAGE NOTCH ELEVATION

FG - TOPSOIL FINISHED GRADE ELEVATION

SCALE: 1'' = 20'

## SITE INFORMATION

SITE ADDRESS: 2453 N HUMBOLDT ST PORTLAND, OR 97217

LOTS 23 & 24, BLOCK 2 OF "BRAINARD TRACT" LOCATED IN THE N.E. 1/4 SECTION 21, T.1N., R.1E., W.M., IN THE CITY OF PORTLAND, MULTNOMAH COUNTY, OREGON

## BENCH MARK INFORMATION

THE DATUM FOR THIS SURVEY IS BASED UPON CITY OF PORTLAND BENCHMARK NO. 458, BRASS DISC IN CURB AT THE N.W. CORNER OF N. SUMNER ST. & N. GAY ST. ELEVATION = 193.41'. COP DATUM.

## **ABBREVIATIONS**

PR - PROPOSED SF - SQUARE FEET

LT ~ LEFT COP - CITY OF PORTLAND ROW - RIGHT OF WAY STD - STANDARD STA - STATION DWG - DRAWING CL – CENTERLINE

PC - POINT OF CURVATURE PT - POINT OF TANGENCY PVC - POINT OF VERTICAL CURVATURE PVT - POINT OF VERTICAL TANGENCY

- MANHOLE - CLEANOUT CSP - CORRUGATED STEEL PIPE

- SANITARY SEWER

CI - CAST IRON

TP - TOP OF PAVEMENT ELEVATION TW - TOP OF WALL ELEVATION TD - TOP OF CHECKDAM ELEVATION

- GUTTER ELEVATION

- SIDEWALK ELEVATION

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- TOP OF CURB ELEVATION

## **BUREAU OF TRANSPORTATION** COMMISSIONER | CHLOE EUDALY COMMISSIONER

**PUBLIC IMPROVEMENTS** N HUMBOLDT ST WEST OF N GAY AVE

**COVER SHEET** 

1 of 9

BES JOB NO.

EP492

PBOT JOB NO.

TH0793

SHEET NO.

ONSTRUCTED BY CAD BY SECTION ENGR PROJECT COMPLETED \_ SWH MAP CORRECTED BY BES REVIEWER HECKED BY CHECKED BY\_ PBOT REVIEWER NO. DATE DESCRIPTION FINAL MAP DATA **REVISIONS** 

NOTICE TO EXCAVATORS:

952-001-0010 THROUGH OAR

CENTER IS 503-232-1987).

NW NATURAL GAS

AFTER HOURS

CENTURYLINK

CITY WATER VERIZON

M-F 7am-6pm

CENTER.

952-001-0090. YOU MAY OBTAIN

THOSE RULES ARE SET FORTH IN OAR

COPIES OF THE RULES BY CALLING THE

POTENTIAL UNDERGROUND FACILITY OWNERS

Dig Safely.

Call the Oregon One-Call Center

DIAL 811 or 1-800-332-2344

EMERGENCY TELEPHONE NUMBERS

CITY BUREAU OF MAINTENANCE 503-823-1700

503-226-4211 Ext.4313

503-226-4211

503-464-7777

503-823-4874

1-800-483-1000

1-800-573-1311

(NOTE: THE TELEPHONE NUMBER FOR

THE OREGON UTILITY NOTIFICATION



REG. PROF. ENGR. 16301PE INCIPAL ENGINEER REG. PROF. ENGR. 75155PE REG. PROF. ENGR. 51538PE

**BUREAU OF ENVIRONMENTAL SERVICES** 


NICK FISH

WILLIAM F. RYAN, P.E.

CHIEF ENGINEER STEVE TOWNSEN, P.E.

CITY ENGINEER

EMERIO Design 6445 SW FALLBROOK PL, STE 100 BEAVERTON, OREGON 97008 TEL: (503) 746-8812

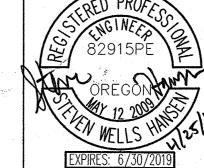

#### **GENERAL NOTES**

- ERRORS AND OMISSIONS ARE THE RESPONSIBILITY OF THE "ENGINEER OF RECORD". IF ERRORS OR OMISSIONS ARE FOUND AFTER THE PERMIT HAS BEEN ISSUED, THE PERMITTEE OR ITS CONTRACTOR SHALL CONTACT THE ENGINEER OF RECORD (STEVE HANSEN OF EMERIO DESIGN AT 503-746-8812) TO HAVE THE CORRECTIONS MADE. ALL CHANGES WILL REQUIRE THE APPROVAL OF THE CITY ENGINEER PRIOR
- 2. THE CONTRACTOR SHALL HAVE AT ALL TIMES ON-SITE, THE APPROVED CONSTRUCTION DRAWINGS & SPECIAL SPECIFICATIONS, CITY OF PORTLAND STANDARD SPECIFICATIONS & STANDARD DRAWINGS, AND ALL OTHER APPLICABLE SPECIFICATIONS BOOKS AND MANUALS. ELECTRONIC EQUIVALENT ARE ACCEPTABLE.
- ALL CONSTRUCTION METHODS AND MATERIALS SHALL CONFORM TO THESE DRAWINGS AND THE APPLICABLE REQUIREMENTS OF THE 2010 FDITION OF THE CITY OF PORTLAND STANDARD CONSTRUCTION SPECIFICATIONS AND ALL REVISIONS AND SPECIAL SPECIFICATIONS.
- 4. A PRECONSTRUCTION CONFERENCE WITH CITY STAFF AND AN APPROVED TEMPORARY TRAFFIC CONTROL PLAN (ISSUED IN CONJUNCTION WITH A STREET /SIDEWALK CLOSURE PERMIT) ARE REQUIRED BEFORE COMMENCING WORK. SEE PERMIT FOR SCHEDULING A PRECONSTRUCTION CONFERENCE AND ACQUISITION OF THE TTCP.
- 5. ELEVATIONS ARE BASED ON CITY OF PORTLAND DATUM FROM BENCH MARK NO. 458, ELEVATION = 193.41, LOCATED AT THE N.W. CORNER OF N. SUMNER ST. & N. GAY ST.
- 6. ATTENTION EXCAVATORS: OREGON LAW REQUIRES YOU TO FOLLOW RULES ADOPTED BY THE OREGON UTILITY NOTIFICATION CENTER. THOSE RULES ARE SET FORTH IN OAR 952-001-0010 THROUGH OAR 952-001-0090. YOU MAY OBTAIN COPIES OF THESE RULES FROM THE CENTER BY CALLING [503.232.1987]. IF YOU HAVE ANY QUESTIONS ABOUT THE RULES, YOU MAY CONTACT THE CALL CENTER. YOU MUST NOTIFY THE CENTER AT LEAST 2 BUSINESS DAYS, BUT NOT MORE THAN 10 BUSINESS DAYS, BEFORE COMMENCING AN EXCAVATION. CALL [811 OR 1-800-332-2344].

#### **ENCROACHMENTS**

STREET FURNISHINGS ARE SHOWN FOR REFERENCE ONLY. THE INSTALLATION OF ALL STREET FURNITURE INCLUDING BUT NOT LIMITED TO BENCHES, NON CITY INSTALLED BIKE RACKS, GARBAGE CANS, ELECTRICAL SYSTEMS (CONDUIT, CONDUCTORS, OUTLETS), AND PUBLIC ART, ARE NOT AUTHORIZED UNDER THIS PERMIT. A SEPARATE REVOCABLE PERMIT IS REQUIRED.

#### UNANTICIPATED CONTAMINATED MATERIAL

REMOVE AND DISPOSE (AT A PROPER LOCATION OR LANDFILL) ALL MATERIALS EXCAVATED FROM WORK IN THE RIGHT-OF-WAY. FOR DISPOSAL ON PRIVATE PROPERTY, SECURE A FILL PERMIT, PRIOR TO BEGINNING WORK FROM THE BUREAU OF DEVELOPMENT SERVICES (BDS). PROVIDE A COPY OF THE APPROVED FILL PERMIT TO THE STREET CONSTRUCTION INSPECTOR.

FOR UNANTICIPATED CONTAMINATED MEDIA ENCOUNTERED, THE PERMITTEE/APPLICANT OR ITS AGENT SHALL BE RESPONSIBLE FOR ALL COSTS ASSOCIATED WITH THE MANAGEMENT, AND DISPOSAL OF CONTAMINATED MEDIA ENCOUNTERED. THE PERMITTEE IS ALSO RESPONSIBLE FOR ALL RESULTANT DELAYS.

THE PERMITTEE OR ITS AGENT SHALL PROVIDE THE CITY (ENGINEERING AND INSPECTION) WITH COPIES OF ALL DISPOSAL PERMITS FROM THE PERMITTED DISPOSAL FACILITY, ANALYTICAL RESULTS USED TO GAIN ACCEPTANCE OF THE CONTAMINATED MEDIA, AND DISPOSAL RECEIPTS/DAILY WEIGH SLIPS. DAILY WEIGH SLIP AMOUNTS SHALL BE CHECKED AGAINST INSPECTOR'S DAILY REPORTS. THE PERMITTEE MUST USE AN OREGON FACILITY FOR DISPOSAL OF THE CONTAMINATED MEDIA.

#### UTILITIES

- UTILITIES SHOWN ON THESE PLANS ARE FOR INFORMATION AND COORDINATION PURPOSES ONLY AND ARE NOT AUTHORIZED FOR INSTALLATION UNDER THE PUBLIC STREET IMPROVEMENT PERMIT. PRIVATE AND PUBLIC UTILITY COMPANIES ARE REQUIRED TO SECURE SEPARATE UTILITY PERMITS FROM THE PBOT FOR ALL WORK WITHIN THE PUBLIC RIGHT-OF-WAY.
- 10. COORDINATION OF ALL UTILITY RELOCATES, REMOVALS, OR INSTALLATION WITHIN THE LIMITS OF WORK IS THE RESPONSIBILITY OF THE PERMITTEE/CONTRACTOR.
- 11. STORM AND SANITARY SEWERS ARE BEING CONSTRUCTED UNDER A SEPARATE PERMIT AS APPROVED BY THE BUREAU OF ENVIRONMENTAL SERVICES.
- 12. WATER MAINS AND SERVICES ARE BEING CONSTRUCTED UNDER A SEPARATE PERMIT AS APPROVED BY THE WATER BUREAU.

#### STREET PAVEMENT

- 13. ALL MANHOLE LIDS AND VALVE BOXES SHALL BE ADJUSTED TO FINISHED STREET GRADE.
- 14. THE STREET INSPECTOR WILL MAKE THE FINAL DETERMINATION OF THE LIMITS OF PAVEMENT RESTORATION, INCLUDING SAWCUT LINES AND SKIN PATCHING. THE PERMITTEE/CONTRACTOR SHALL CONSULT WITH THE STREET INSPECTOR PRIOR TO SAWCUTTING OR DEMOLISHING OF
- 15. SAWCUTS SHALL BE STRAIGHT MATCHLINES TO CREATE A BUTT JOINT BETWEEN THE EXISTING PAVEMENT AND NEW PAVEMENT AND ALL NEW PAVEMENT JOINTS SHALL BE SAND SEALED.
- 16. EXISTING PAVEMENT SECTION WIDTHS OF 2 FEET OR LESS BETWEEN PROPOSED SAWCUT AND EXISTING PAVEMENT EDGE (I.E. UTILITY TRENCH REPAIR), SHALL BE RESTORED PER STD. DWG. P-505.
- 17. PAVEMENT SECTION SHALL BE AS SHOWN ON THE STREET TYPICAL SECTION(S) OR MATCH EXISTING PAVEMENT IF EXISTING IS A THICKER SECTION.

#### **CURBS, SIDEWALKS, AND DRIVEWAYS**

- 18. UTILITY LIDS, MANHOLE COVERS, VALVE COVERS (THAT ARE NOT SHOWN ON THESE CONSTRUCTION DRAWINGS) ARE NOT ALLOWED IN THE THROUGH PEDESTRIAN ZONE. THEY MUST BE PLACED IN THE SIDEWALK FURNISHING OR BUILDING ZONE IF THE PROPER PBOT UTILITY PERMIT HAS BEEN SECURED.
- 19. FULL HEIGHT CURBS SHALL BE CONSTRUCTED AT ALL LOCATIONS UNLESS A NEW DRIVEWAY IS CONSTRUCTED AT THE SAME TIME AS THE
- 20. ALL SIDEWALK CONTRACTION JOINTS SHALL BE PER SECTION 00759.49 "CONTRACTION JOINTS" OF THE STANDARD CONSTRUCTION SPECIFICATION AND CITY STANDARD DWG P-551.
- 21. NO FUTURE DRIVEWAYS SHALL BE CONSTRUCTED UNLESS THERE IS A BUILDING PERMIT ISSUED FOR AN ON-SITE PARKING SPACE, OR OTHER APPROVAL FROM BDS.
- 22. CONTRACTOR MAY USE CONCRETE OR ASPHALT CONCRETE FROM THE PRE-APPROVED MIX DESIGNS LIST IF AVAILABLE. IF NOT, THE CONTRACTOR WILL NEED TO SUBMIT A MIX DESIGN FOR APPROVAL.
- 23. USE ONLY APPROVED DETECTABLE WARNING DEVICES FROM THE CITY'S CONSTRUCTION PRODUCTS LIST (CPL).
- 24. ALL DRIVEWAYS ARE REQUIRED TO HAVE A MINIMUM OF 3 FEET OF HARD SURFACING BEHIND SIDEWALK (SEE STD DWG P-536).

#### **STORM SEWER PIPE**

- 25. THE ACCEPTABLE INLET LEAD PIPE MATERIALS ARE AS FOLLOWS:
  - C.S.P. ASTM C 14, CLASS 3 WITH CLASS 'B' BEDDING AND BACKFILL
  - HDPE D 3035 SDR 26 WITH FLEXIBLE PIPE BEDDING AND GRANULAR BACKFILL
  - PVC ASTM D 3034 SDR 35 WITH FLEXIBLE PIPE BEDDING AND GRANULAR BACKFILL. PIPE BEDDING AND BACKFILL PER STANDARD PLAN NOS. P-100 AND P-101.
- SURFACING PER STD, DWG. P-515, P-516 AND P-517.
- 26. FOR PLUGGING OF ABANDONED SEWER PIPES, AND FILLING ABANDONED PIPES, MANHOLES, AND CATCH BASINS, SEE SECTIONS 00490.43 AND 00490.44 RESPECTIVELY OF THE STANDARD SPECIFICATION.

#### CATCH BASINS AND INLETS

27. ALL CATCH BASIN AND INLETS SHALL BE CAST-IN-PLACE, CONSTRUCT CAST-IN-PLACE CATCH BASINS AND INLETS ACCORDING TO SECTION 00470.

#### TRAFFIC AND PARKING CONTROL

- 28. THE CONTRACTOR MUST ACQUIRE AN APPROVED TEMPORARY STREET USE PERMIT (TSUP) PRIOR TO CLOSURE OF ANY STREET, SIDEWALK, TRAVEL LANE OR PARKING LANE. THE TSUP IS ACQUIRED FROM THE PERMIT CENTER LOCATED AT 1900 SW 4TH AVENUE.
- 29. THE CONTRACTOR SHALL NOT REMOVE OR COVER ANY TRAFFIC CONTROL SIGNS, PAVEMENT MARKINGS, OR BARRICADES THAT ARE NOT IDENTIFIED ON THE APPROVED TEMPORARY TRAFFIC CONTROL PLAN.
- 30. THE CONTRACTOR SHALL MAINTAIN ALL NECESSARY TEMPORARY TRAFFIC CONTROL DEVICES (INCLUDING BUT NOT LIMITED TO THE FOLLOWING -SIGNS, PAVEMENT MARKINGS, AND BARRICADES) UNTIL THE PERMANENT TRAFFIC CONTROL DEVICES ARE INSTALLED.
- 31. WHEN WORK INTERFERES WITH THE OPERATION OF A TRIMET BUS OR BUS STOP, CONTACT TRIMET AT 503-962-4949 A MINIMUM OF 14 DAYS PRIOR TO CLOSING OR DISRUPTING TRIMET'S OPERATION.
- 32. THE CONTRACTOR SHALL INSTALL OR REINSTALL ALL PERMANENT TRAFFIC CONTROL SIGNING, CURB AND PAVEMENT MARKINGS, AND BARRICADES.
- 33. THE CONTRACTOR SHALL SUBMIT MATERIALS LIST FOR APPROVAL 14 DAYS PRIOR TO INSTALLING PERMANENT TRAFFIC CONTROL SIGNING, CURB AND PAVEMENT MARKINGS, AND BARRICADES.
- 34. ALL NEW SIGN MATERIALS SHALL COMPLY WITH SECTION 2910 OF THE CITY OF PORTLAND STANDARD CONSTRUCTION SPECIFICATIONS. ALL SIGNS SHALL BE TYPE III OR IV BACKGROUND SHEETING ON ALUMINUM SIGN BLANKS. SIGN TYPES FOR EACH SIGN, AS SPECIFIED IN SECTION 2910.02, ARE NOTED IN THE PLANS.
- 35. SIGNS AND SIGN POSTS REMOVED BY THE PERMITTEE OR ITS AGENT SHALL BE DELIVERED TO THE BUREAU OF MAINTENANCE, ALBINA YARD. CONTACT 503-823-4056 TO ARRANGE A DELIVERY TIME. REMOVE ALL SIGNS, CONCRETE AND DEBRIS FROM THE POST PRIOR TO DELIVERY.
- 36. ALL CURB AND PAVEMENT MARKING MATERIALS SHALL BE ON THE CITY'S CONSTRUCTION PRODUCTS LIST (CPL) OR THE STATE'S QUALIFIED PRODUCTS LIST (QPL). ALL MATERIALS SHALL BE INSTALLED IN CONFORMANCE WITH THE MANUFACTURERS APPROVED APPLICATION PROCEDURE.
- 37. ALL LONGITUDINAL LINE WORK TO BE METHOD B (NON-PROFILE) EXTRUDED THERMOPLASTIC, 120 MILS THICK.
- 38. ALL TRANSVERSE LINE WORK, LEGENDS, SYMBOLS, AND ARROWS SHALL BE TYPE "B-HS" PREFORMED THERMOPLASTIC. BIKE LANE STENCILS, GREEN BICYCLE LANE MARKINGS, AND BIKE PATH RAILROAD MARKINGS SHALL BE 90 MILS THICK. ALL OTHER TRANSVERSE PAVEMENT MARKINGS SHALL BE 120-125 MILS THICK.
- 39. THE CONTRACTOR SHALL REPAIR OR REPLACE ANY CURB OR PAVEMENT MARKINGS DAMAGED, WORN OUT OR REMOVED DUE TO CONTRACTOR'S OPERATION.
- 40. OUTSIDE METERED DISTRICTS: PARKING CONTROL SIGNING WILL BE INSTALLED BY THE CONTRACTOR. CONTACT PARKING CONTROL AT 503-823-7275 14 DAYS PRIOR TO INSTALLATION TO IDENTIFY EXACT SIGN LOCATIONS.

#### **TREES**

- 42. ALL TREE REMOVAL SHALL COMPLY WITH THE FEDERAL MIGRATORY BIRD TREATY ACT. SEE THE SPECIAL PROVISIONS FOR REQUIREMENTS PRIOR TO CUTTING OF ANY TREE.
- 43. ALL GROUND DISTURBANCES NEAR TREES REQUIRES ROOT INSPECTION!! CONTACT URBAN FORESTRY (URBAN FORESTRY AT 503-823-8733; FOR ROOT INSPECTIONS PRESS 3) PRIOR TO ALL EXCAVATIONS ADJACENT TO TREES. CONSULTATION WITH THE URBAN FORESTER IS REQUIRED BEFORE CUTTING OF
- 44. FOR ALTERNATE TREE SPECIES OR ALTERNATE TREE PLANTING LOCATION APPROVAL (PRIOR TO PLANTING), CONTACT URBAN FORESTRY AT 503-823-8733; TO LEAVE A MESSAGE FOR THE TREE INSPECTOR PRESS 5.

#### **EROSION CONTROL**

46. EROSION/SEDIMENTATION CONTROL (ESC) IS REQUIRED ON THIS PROJECT. IMPLEMENTATION OF THE FSC AND THE CONSTRUCTION. MAINTENANCE, REPLACEMENT, AND UPGRADING OF THESE ESC FACILITIES IS THE RESPONSIBILITY OF THE PERMITTEE OR IT'S AGENT UNTIL ALL CONSTRUCTION IS COMPLETED AND APPROVED. THE PERMITTEE OR IT'S AGENT SHALL PROVIDE INLET PROTECTION TO DOWNSTREAM INLETS FROM THE SITE PER THE EROSION CONTROL MANUAL [MARCH 2008]. CATCH BASIN AND STORM DRAIN INLET PROTECTION SHALL BE INSTALLED PER DETAIL DRAWINGS 4.3-B AND 4.3-G.

#### FOR JOINT PBOT/BES PERMITS ONLY


- 47. DISPOSE OF ALL SEWER TRENCH SPOIL MATERIAL AT A PROPER LANDFILL, OR SHALL OBTAIN A PERMIT FROM THE BUREAU OF DEVELOPMENT SERVICES BEFORE BEING DISPOSED OF ON-SITE. A COPY OF THE GRADING PERMIT AND PLAN SHALL BE PROVIDED TO THE BUREAU OF ENVIRONMENTAL SERVICES FOR CONSTRUCTION INSPECTION AT THE PRE-CONSTRUCTION MEETING. ALL WORK OUTSIDE THE PUBLIC RIGHT-OF-WAY, INCLUDING CUTS, FILLS, GRADING, AND CLEARING MAY REQUIRE PERMITS FROM THE BUREAU OF DEVELOPMENT SERVICES.
- 48. FOUNDATION STABILIZATION MAY BE NECESSARY AS PER CITY OF PORTLAND'S STANDARD CONSTRUCTION SPECIFICATIONS AND APPROVED
- 49. MARK THE ENDS OF ALL STUB OUTS AND LATERALS WITH CONTINUOUS PRESSURE TREATED 2" X4" LUMBER. THE TOP 12' SHALL BE PAINTED WHITE AND STENCILED WITH BLACK "ST" FOR STORM OR PAINTED GREEN AND STENCILED BLACK "SS" FOR SANITARY, AND WITH PIPE SIZE, MATERIAL TYPE, AND PIPE DEPTH. BURY THE 2" X 4" LUMBER TO THE STUB OR LATERAL
- 50. PROPERLY SHORE AND BRACE ALL SEWER TRENCH LINES AND EXCAVATIONS TO PREVENT CAVING AS REQUIRED BY OREGON OCCUPATIONAL SAFETY AND HEALTH ADMINISTRATION (OR-OSHA) AND SECTION 00510 - "STRUCTURE EXCAVATION AND BACKFILL" OF THE STANDARD CONSTRUCTION SPECIFICATIONS.
- 51. THE PERMITTEE OR IT'S AGENT SHALL BE RESPONSIBLE FOR THE OPERATIONS AND MAINTENANCE OF THE STORMWATER FACILITIES AS PRESCRIBED IN THE APPROVED "OPERATIONS & MAINTENANCE" PLAN FOR 2 YEARS AFTER ITS ACCEPTANCE BY THE CITY.

NICK FISH

WILLIAM F. RYAN, P.E.

#### EX ROW EX-32' HALF STREET ROW 0.5 20' NEW PAVEMENT SAWCUT LINE PER P-506 FRONTAGE 6' PEDESTRIAN 8' FURNISHING 15' ZONE ZONE ZONE 1' BENCH VARIES -3.5% TO 1.5% 0.0% 2.0% CONSTRUCT PAVEMENT - 6" PCC OVER 8" AGGREGATE BASE ROCK COMPACTED STRUCTURAL PER STD DWG P-523 FILL MATERIAL PER CONSTRUCT STANDARD CURB AASHTO T99 PER STD DWG P-540 CONSTRUCT 6' STANDARD SIDEWALK PER STD DWG P-551 — 6" TOPSOIL WITH GRASS SEED FOR 3'X3' SCORE PATTERN PERMANENT EROSION CONTROL

N HUMBOLDT ST - TYPICAL SECTION W/O SWALE FROM STA 1+19.50 TO 1+23.35, STA 1+30.35 TO 1+53.00. AND STA 1+60.00 TO 1+77.00 SCALE: 1"=5'

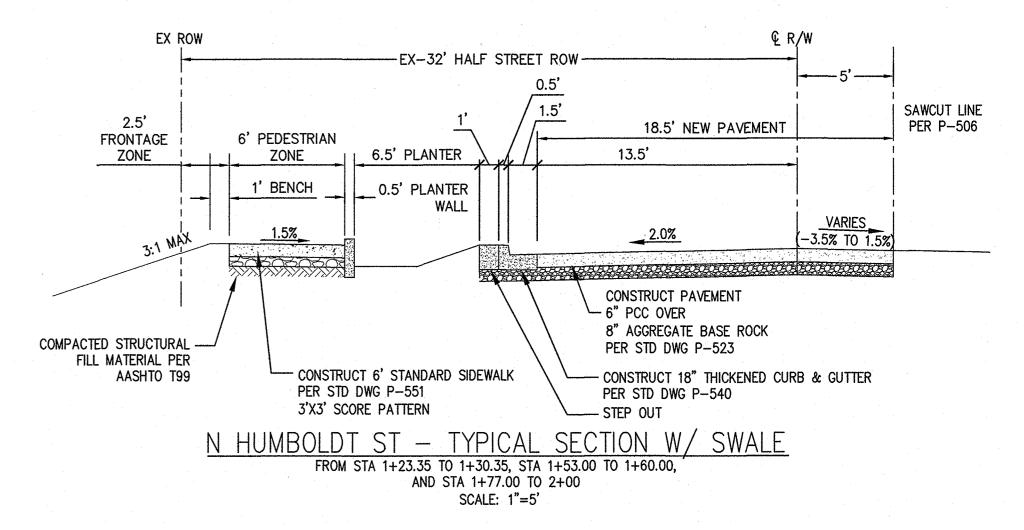

SWH CONSTRUCTED BY SECTION ENGR PROJECT COMPLETED SWH IAP CORRECTED BY HECKED BY BES REVIEWER CHECKED BY NO. DATE DESCRIPTION PBOT REVIEWER FINAL MAP DATA **REVISIONS** 



APPROVALS: PROF. ENGR. 16301PE PRINCIPAL ENGINEER REG. PROF. ENGR. 75155PE PBOT CITY ENGINEER REG. PROF. ENGR. 51538PE

BUREAU OF **ENVIRONMENTAL SERVICES** 

BUREAU OF TRANSPORTATION

COMMISSIONER

CITY ENGINEER


COMMISSIONER | CHLOE EUDALY CHIEF ENGINEER STEVE TOWNSEN, P.E. EMERIC 6445 SW FALLBROOK PL, STE 100 BEAVERTON, OREGON 97008 TEL: (503) 746-8812 www.emeriodesign.com

**PUBLIC IMPROVEMENTS** N HUMBOLDT ST WEST OF N GAY AVE

**NOTES AND TYPICAL SECTIONS** 

EP492 PBOT JOB NO. TH0793 SHEET NO.

BES JOB NO.

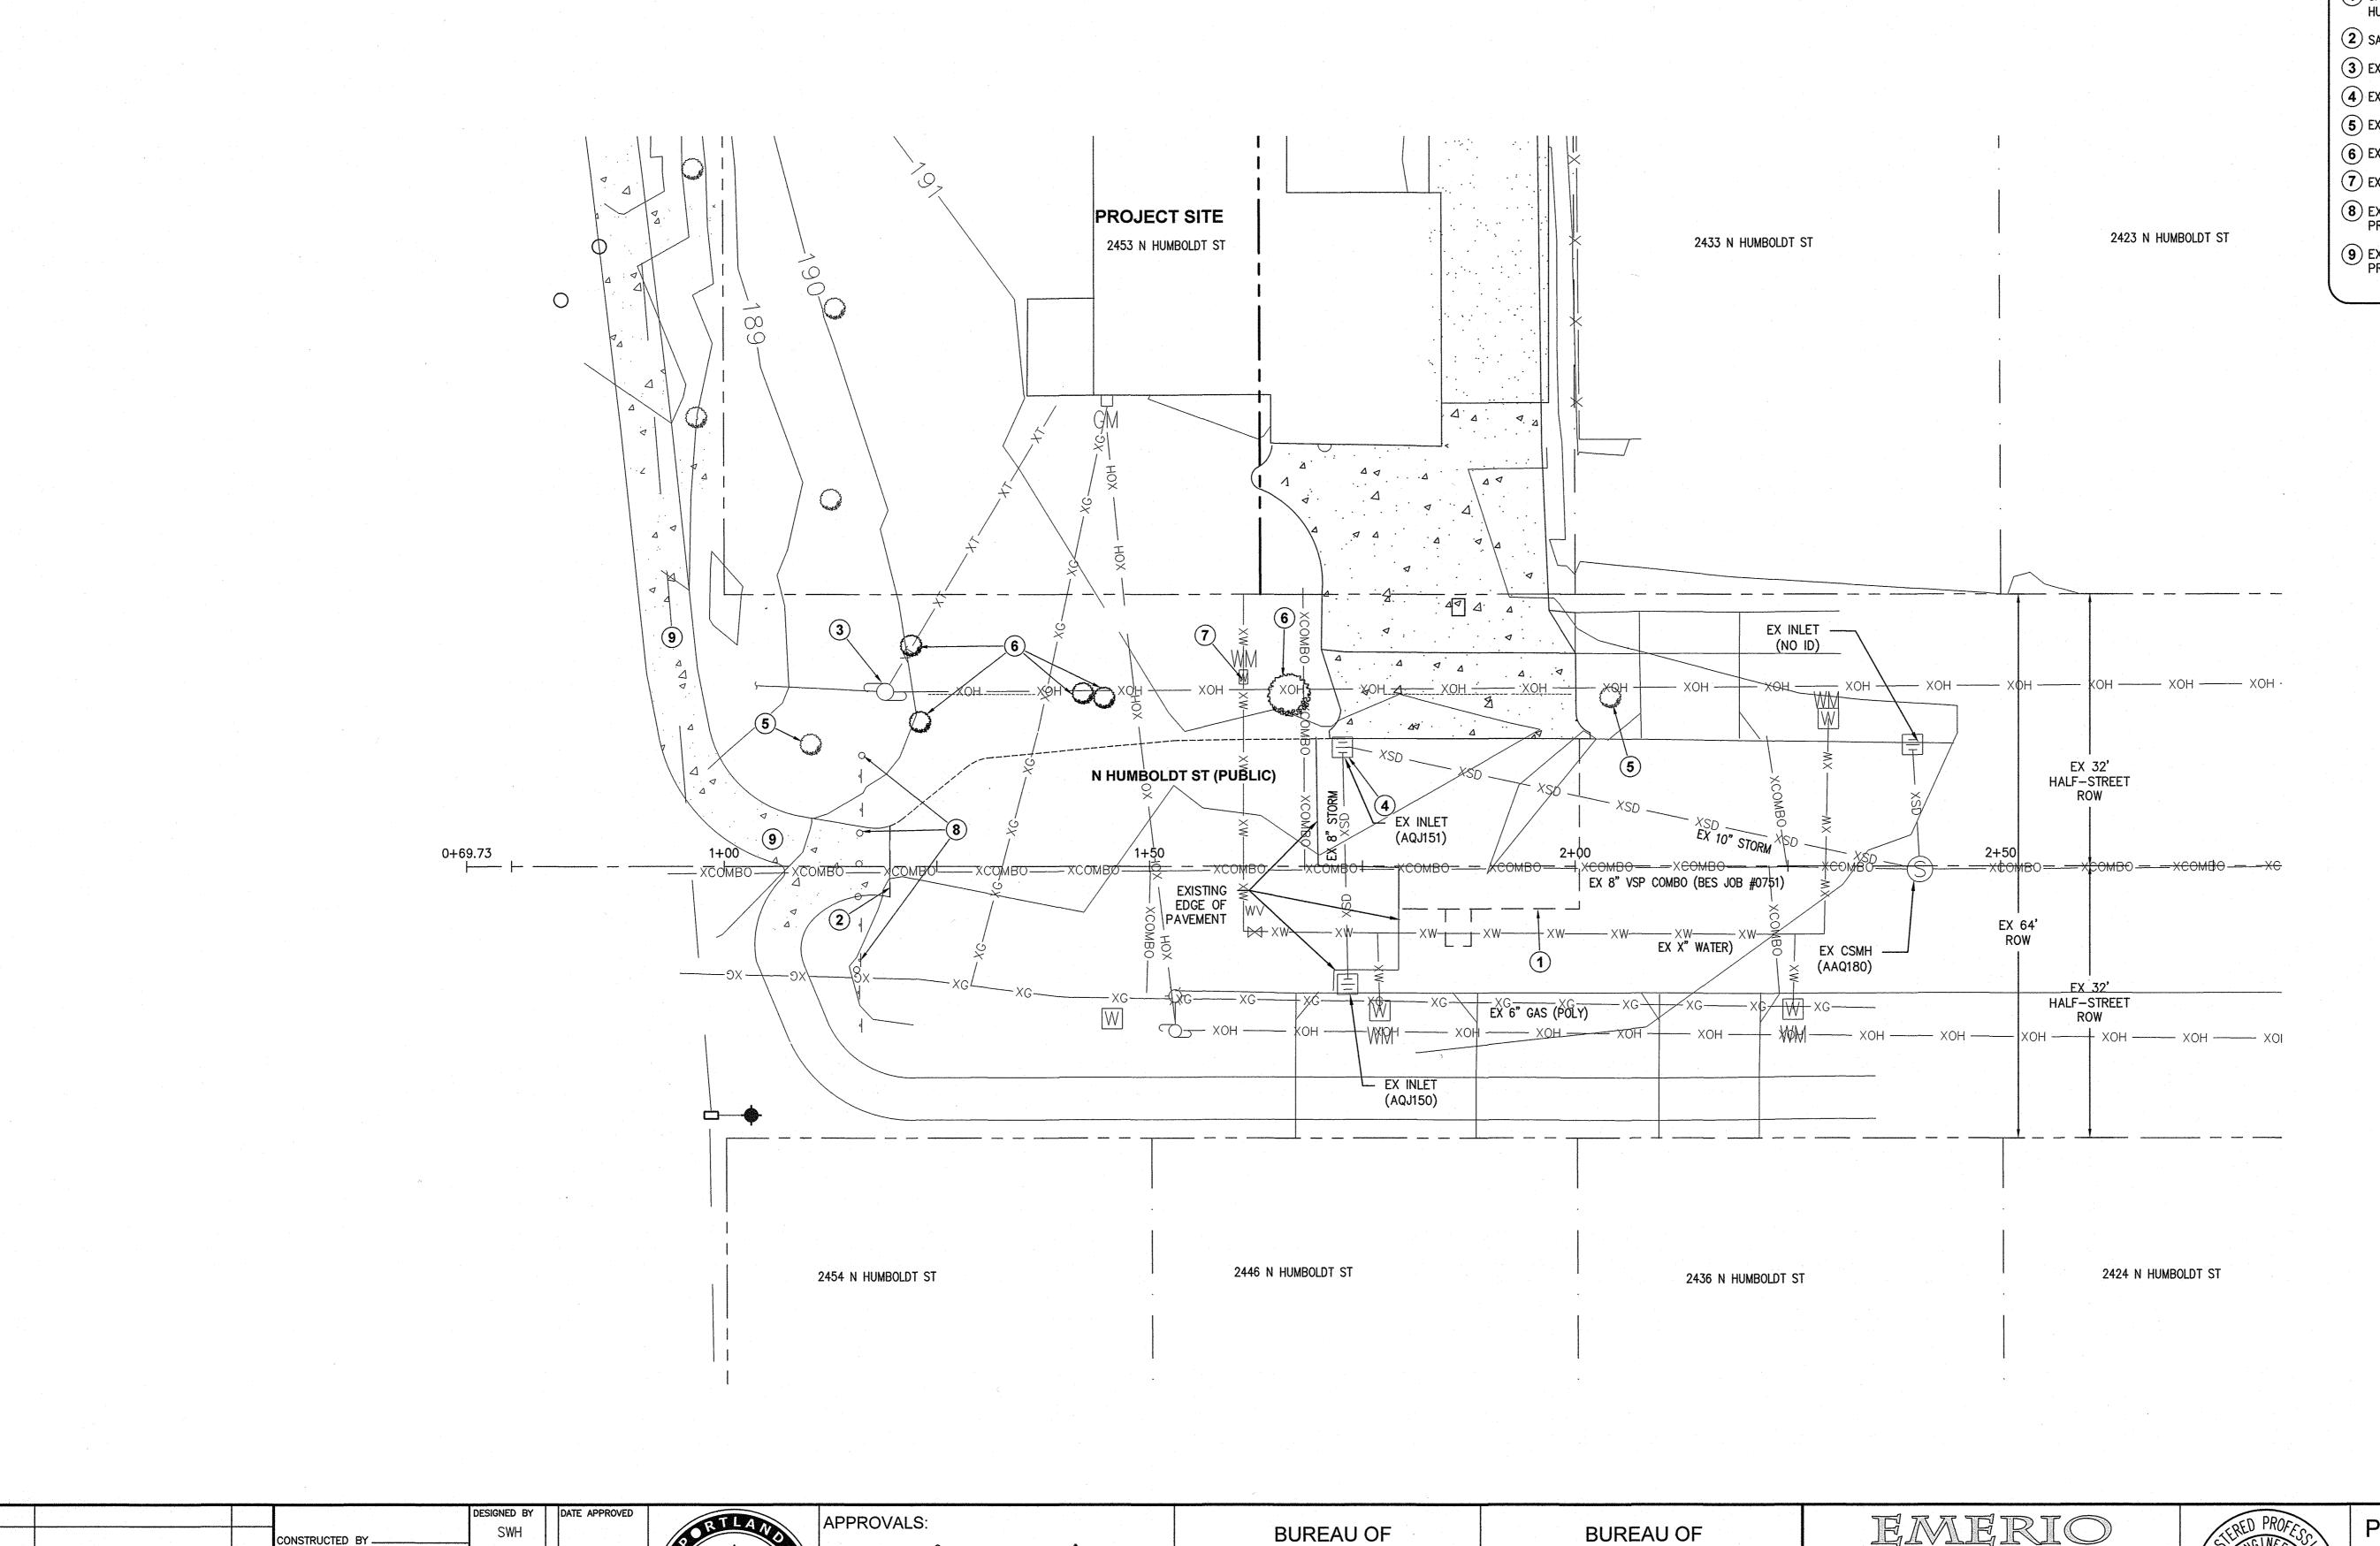

**ENVIRONMENTAL SERVICES** 

COMMISSIONER | CHLOE EUDALY

CHIEF ENGINEER STEVE TOWNSEN, P.E.

NICK FISH

WILLIAM F. RYAN, P.E.

5/13/19 REG. PROF. ENGR. 16301PE

REG. PROF. ENGR. 75155PE

REG. PROF. ENGR. 51538PE

5/14/19

PBOT CITY ENGINEER

BES REVIEWER

PBOT REVIEWER

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FINAL MAP DATA


NO. DATE

DESCRIPTION

**REVISIONS** 

DEMOLITION NOTES

- 1 SAWCUT AND REMOVE EX CONCRETE AND DRIVEWAY ALONG N HUMBOLD ST FROM STA 1+79.26, 5.0'RT TO STA 2+00.50, 5.0'RT
- 2 SAWCUT AND REMOVE EX AC ACCESS PATH EAST OF STA 1+17.05
- (3) EXISTING UTILITY POLE TO REMAIN AND BE PROTECTED
- (4) EXISTING INLET TO REMAIN AND BE PROTECTED
- (5) EXISTING STREET TREE TO REMAIN AND BE PROTECTED
- (6) EXISTING SHRUBS TO BE REMOVED
- **7** EXISTING 3/4" WATER METER REMAIN AND BE PROTECTED.
- 8 EXISTING BOLLARDS AND BARRICADES TO REMAIN AND BE PROTECTED
- EXISTING CONCRETE SIDEWALK TO REMAIN AND BE PROTECTED

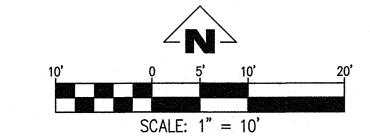

6445 SW FALLBROOK PL, STE 100 BEAVERTON, OREGON 97008 TEL: (503) 746-8812

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TRANSPORTATION

COMMISSIONER


CITY ENGINEER


PUBLIC IMPROVEMENTS N HUMBOLDT ST WEST OF N GAY AVE

**EXISTING CONDITIONS** AND DEMOLITION PLAN

PBOT JOB NO. TH0793 SHEET NO. 3 of 9

EP492

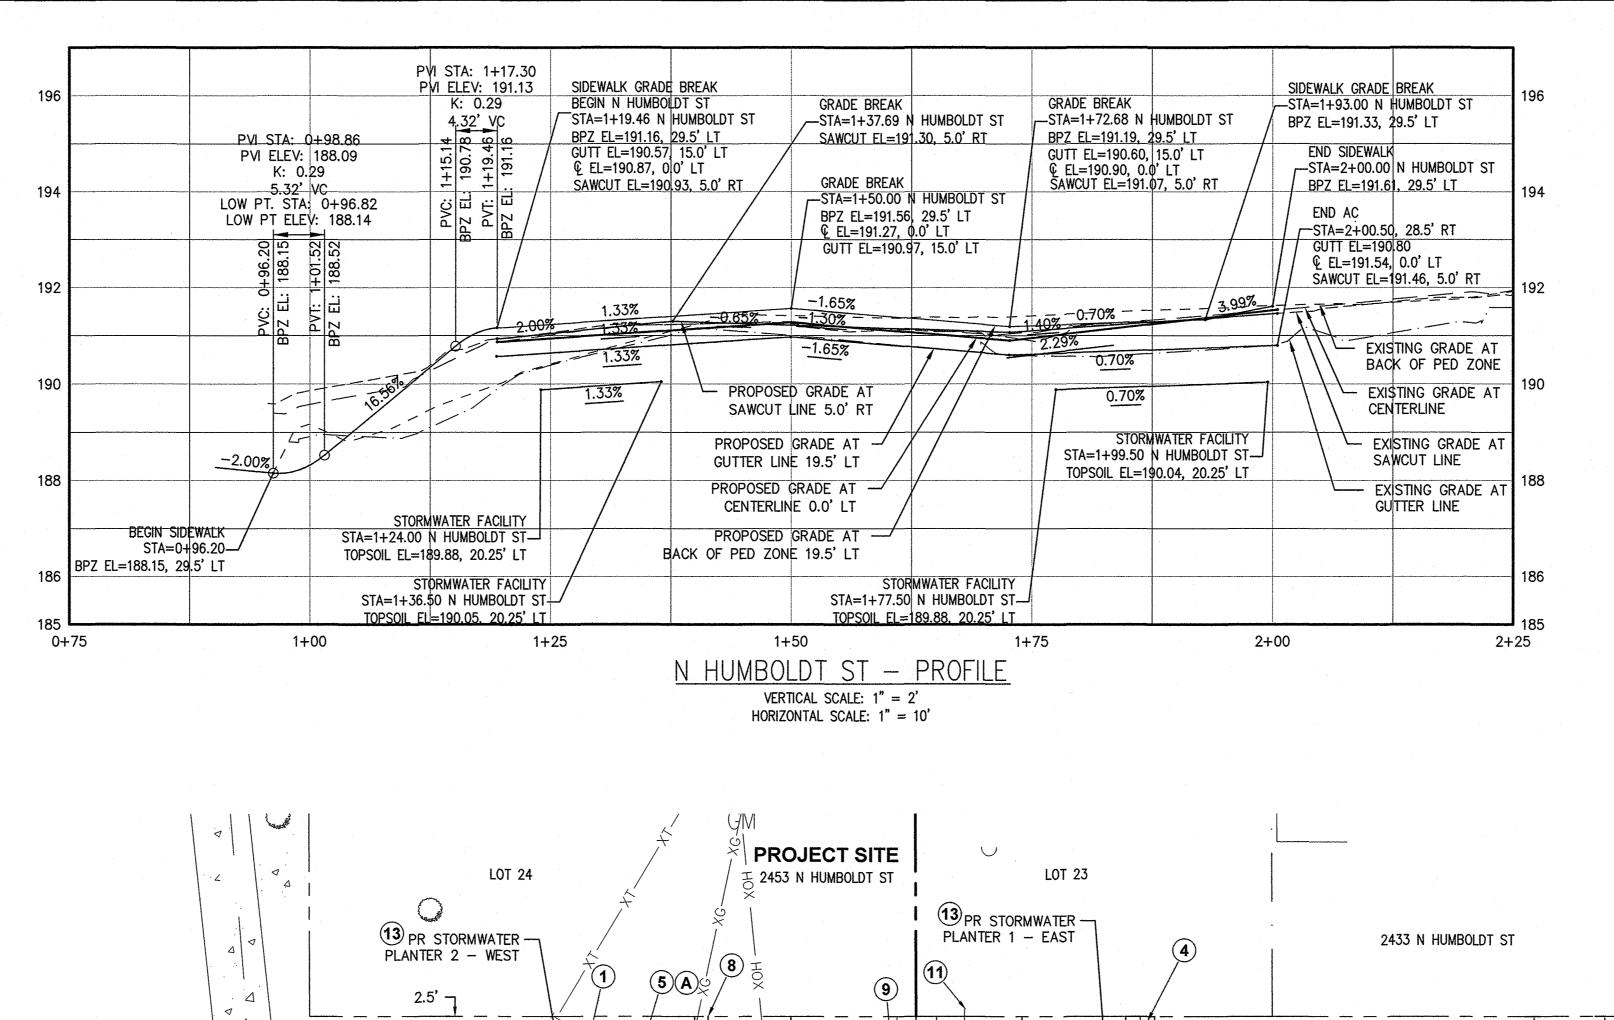

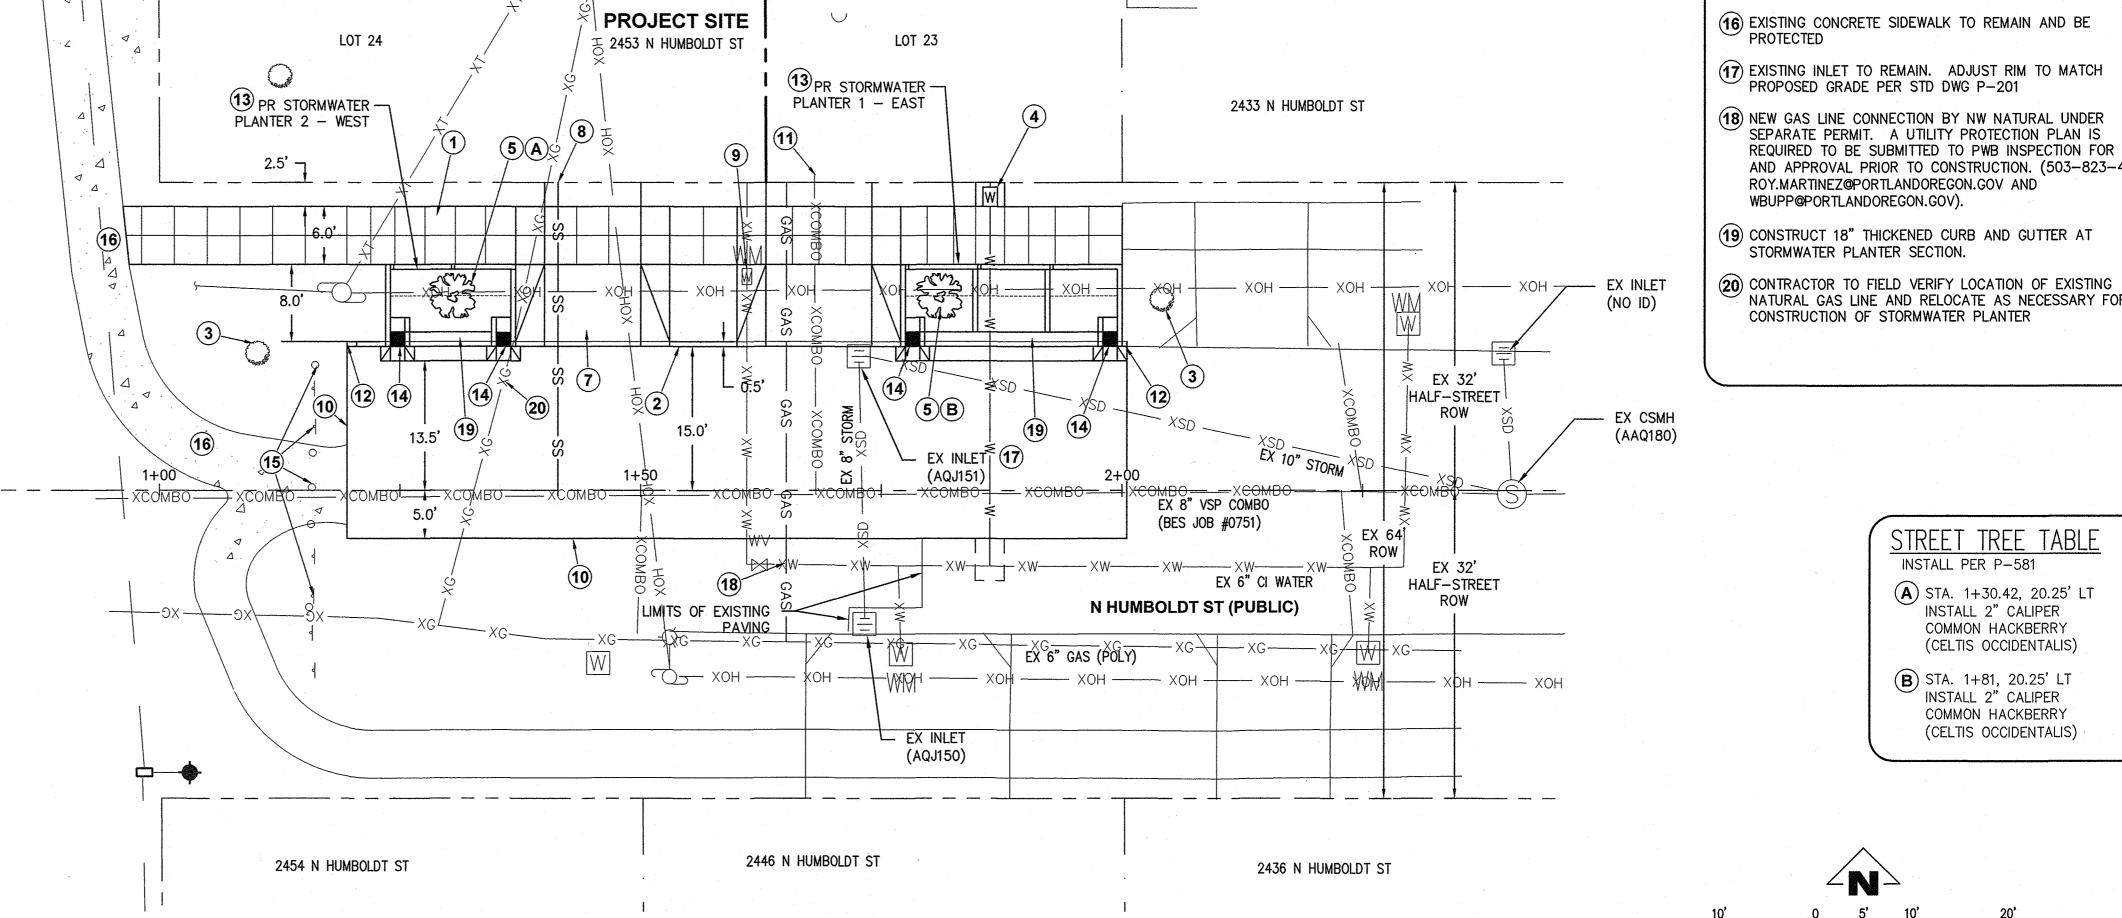

N HUMBOLDT ST - PLAN SCALE: 1"=10'

BES REVIEWER RRK

PBOT REVIEWER

CHECKED BY

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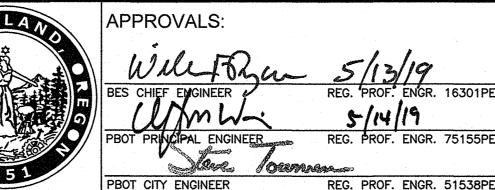
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CHECKED BY

NO. DATE

DESCRIPTION

**REVISIONS** 



**BUREAU OF ENVIRONMENTAL SERVICES** 

NICK FISH

WILLIAM F. RYAN, P.E.


BUREAU OF TRANSPORTATION

COMMISSIONER | CHLOE EUDALY COMMISSIONER CHIEF ENGINEER | STEVE TOWNSEN, P.E. CITY ENGINEER EMERIO 6445 SW FALLBROOK PL, STE 100

BEAVERTON, OREGON 97008

TEL: (503) 746-8812

www.emeriodesign.com

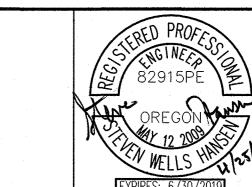

**PUBLIC IMPROVEMENTS** N HUMBOLDT ST WEST OF N GAY AVE

SCALE: 1" = 10'

CONSTRUCTION NOTES

LINE FOR WATER METER PROTECTION.

CONCRETE PER STD DWG P-536.

BEHIND CONCRETE PER STD DWG P-536.

SEPARATE BES CONNECTION PERMIT

DWG P-511

PROTECTED

(1) CONSTRUCT 6' SIDEWALK PER STD DWG P-551 WITH 3'X3' SCORE

(2) CONSTRUCT STANDARD CURB PER STD DWG P-540, 6" CURB

(3) EXISTING STREET TREE TO REMAIN AND BE PROTECTED

(5) INSTALL 2" CALIPER STREET TREE PER STD DWG P-581.

(4) INSTALL 1" METER BY PORTLAND WATER BUREAU UNDER SEPARATE

PERMIT. CONTRACTOR TO CONNECT TO THE SHORT STUB-OUT ON

THE BACK-SIDE OF THE NEW WATER METER BOX. CONTRACTOR TO

EXTEND SIDEWALK PANEL ADJACENT TO WATER METER TO PROPERTY

(6) CONSTRUCT 11' CONCRETE DRIVEWAY AT STA. 1+68.50 PER STD DWG

(7) CONSTRUCT 10' CONCRETE DRIVEWAY AT STA. 1+45.00 PER STD

(8) SANITARY LATERAL TO BE CONSTRUCTED AT STA. 3+70.65 UNDER

(9) PROTECT METER. CONTRACTOR TO RESET METER BOX TO

IF A NEW METER BOX IS NECESSARY (503-823-1533)

(10) CONSTRUCT PAVEMENT. 6" PCC OVER 8" AGGREGATE BASE ROCK

(13) CONSTRUCT FLOW—THROUGH STORMWATER MANAGEMENT

PLANTERS. SEE SHEET 6 FOR STORMWATER FACILITY GRADING, PLANTING PLAN AND TYPICAL SECTION.

(14) CONSTRUCT CONCRETE INLET. SEE DETAIL ON SHEET 7

(15) ALL EXISTING BOLLARDS AND BARRICADES AT END OF N HUMBOLDT ST TO REMAIN AND BE PROTECTED

SEPARATE PERMIT. A UTILITY PROTECTION PLAN IS

NATURAL GAS LINE AND RELOCATE AS NECESSARY FOR

STREET TREE TABLE

(A) STA. 1+30.42, 20.25' LT

INSTALL 2" CALIPER

COMMON HACKBERRY (CELTIS OCCIDENTALIS)

**(B)** STA. 1+81, 20.25' LT INSTALL 2" CALIPER COMMON HACKBERRY (CELTIS OCCIDENTALIS)

INSTALL PER P-581

REQUIRED TO BE SUBMITTED TO PWB INSPECTION FOR REVIEW AND APPROVAL PRIOR TO CONSTRUCTION. (503-823-4518,

(11) EX SANITARY LATERAL TO REMAIN AND SERVE LOT 23

(12) CONSTRUCT CURB END PER STD DWG P-544

PROPOSED GRADE PER STD DWG P-201

ROY.MARTINEZ@PORTLANDOREGON.GOV AND

CONSTRUCTION OF STORMWATER PLANTER

WBUPP@PORTLANDOREGON.GOV).

STORMWATER PLANTER SECTION.

GRADE AS NECESSARY. CONTACT PORTLAND WATER BUREAU

PER STD DWG P-523 AND NON CURBED PAVEMENT EDGE PER STD

P-528. PROVIDE MINIMUM 3' PAVED DRIVEWAY CONNECTION BEHIND


DWG P-529. PROVIDE MINIMUM 3' PAVED DRIVEWAY CONNECTION

N HUMBOLDT ST PLAN **AND PROFILE** 


PBOT JOB NO. TH0793 SHEET NO.

4 of 9


EP492

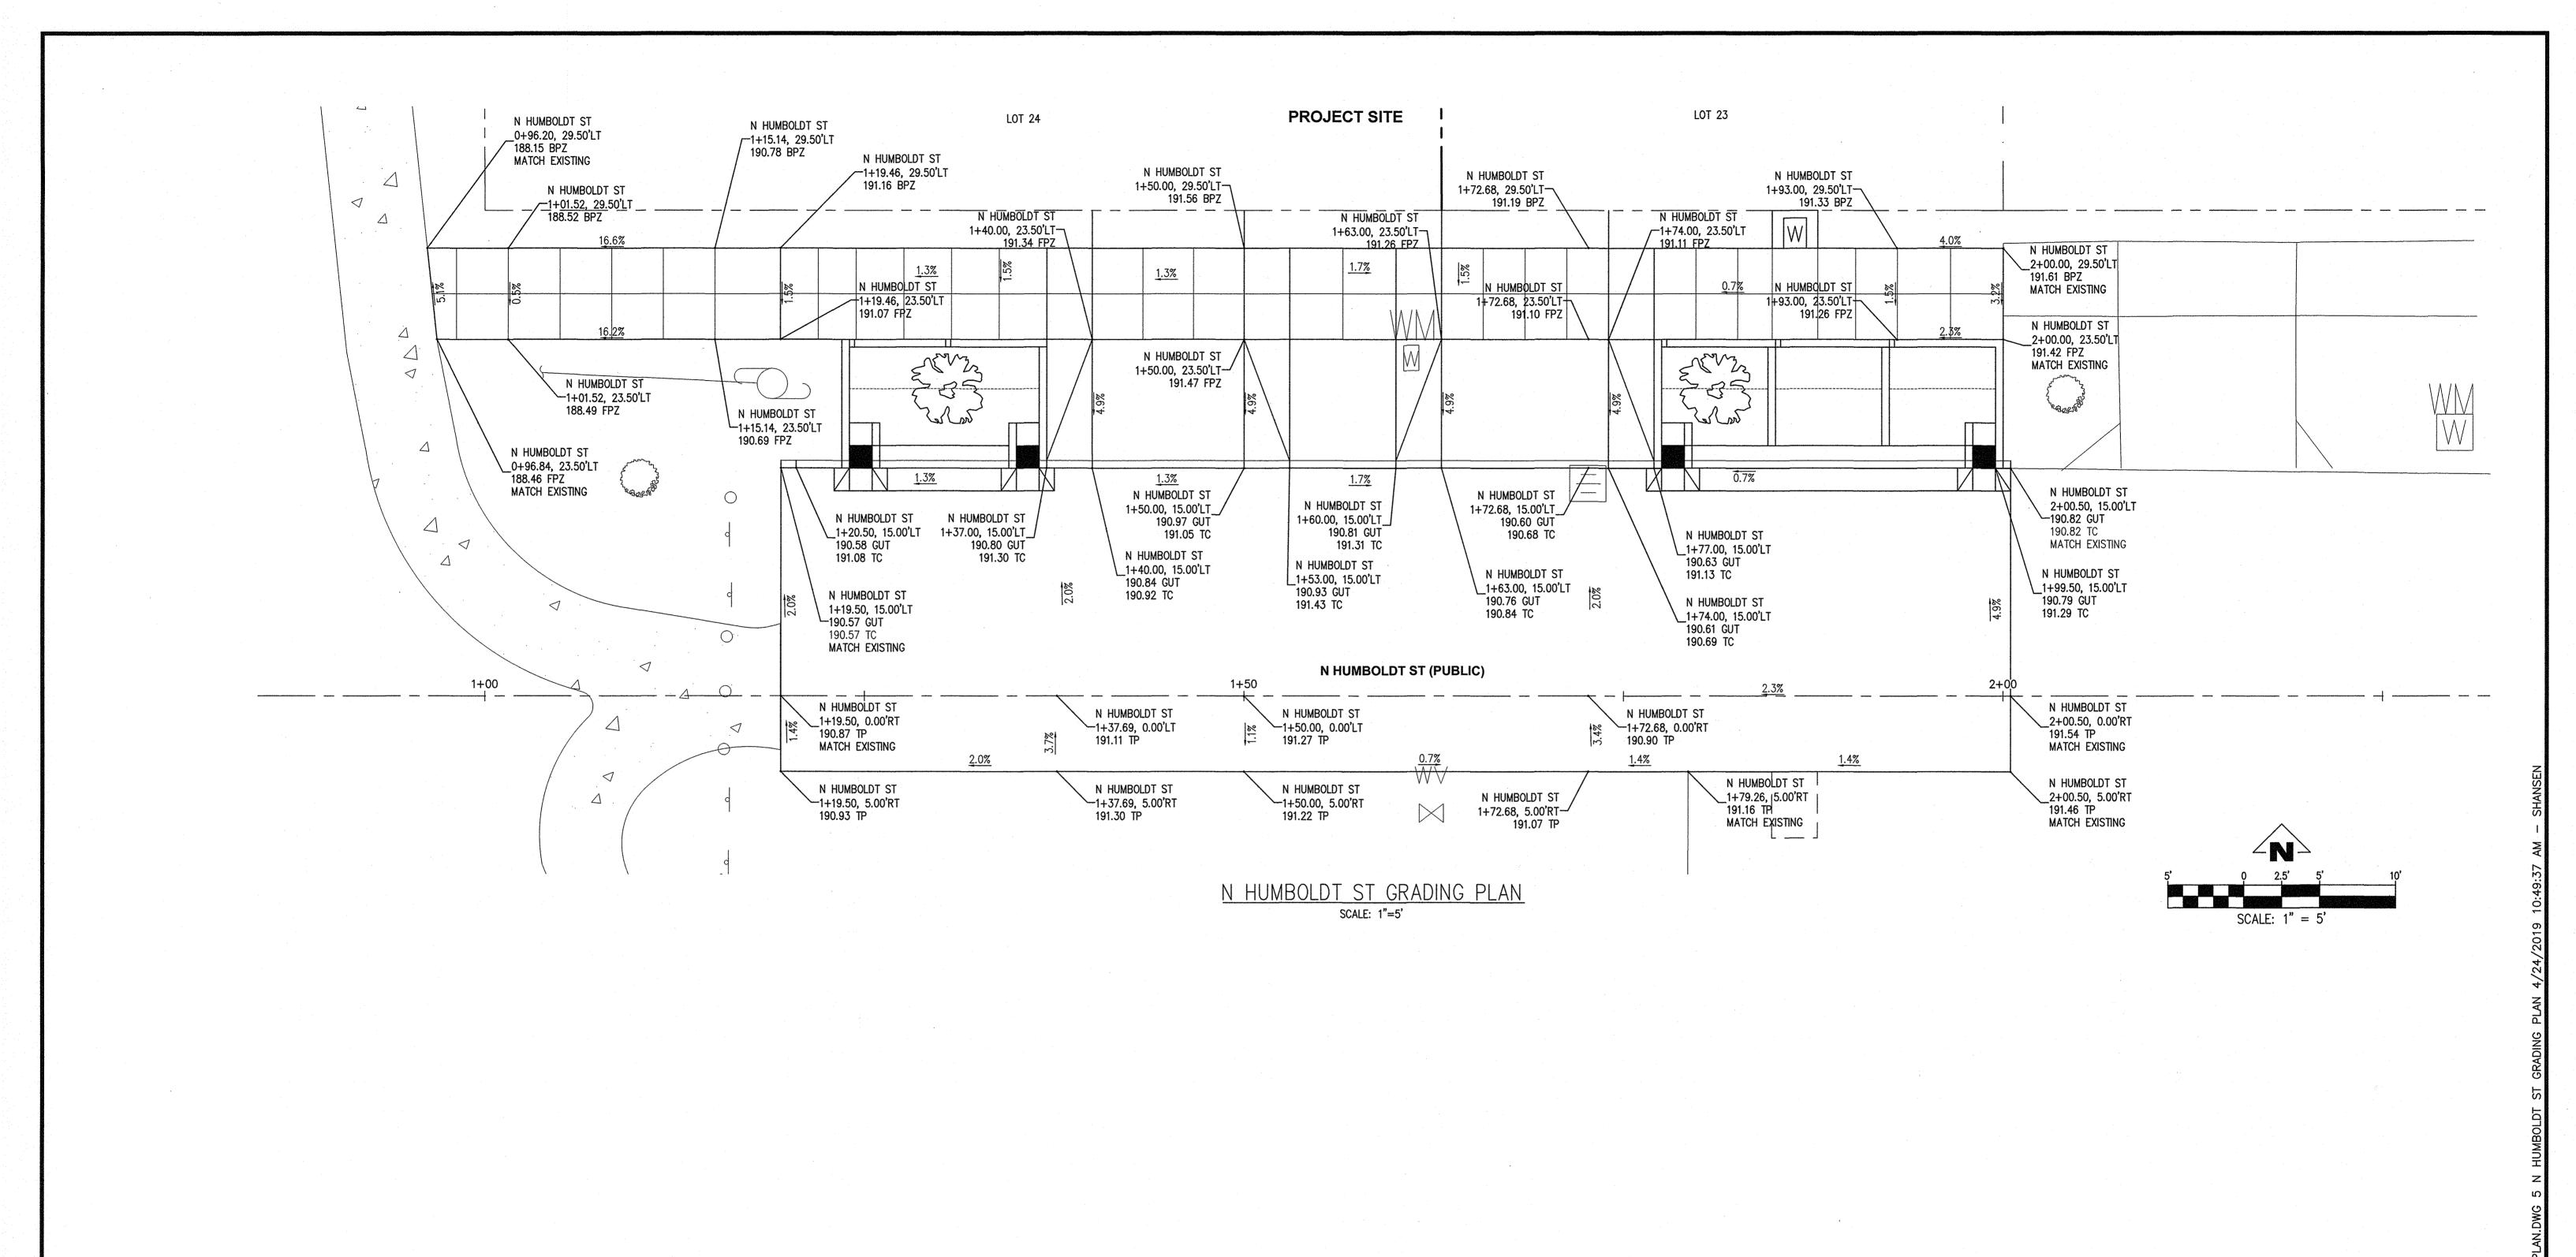

					DESIGNED BY	DATE APPROVED
	***************************************			CONSTRUCTED BY	SWH	
				PROJECT COMPLETED	CAD BY SWH	SECTION ENGR
	. 7			MAP CORRECTED BY		
					CHECKED BY SWH	BES REVIEWER  [LIK
				CHECKED BY	3W11 ·	
NO.	DATE	DESCRIPTION	APPD.			PBOT REVIEWER
		REVISIONS		FINAL MAP DATA		AM

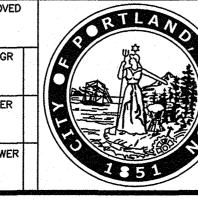

PBOT CITY ENGINEER

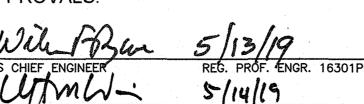

5/13/19 REG. PROF. ENGR. 16301PE REG. PROF. ENGR. 75155PE

REG. PROF. ENGR. 51538PE

**BUREAU OF ENVIRONMENTAL SERVICES** 

COMMISSIONER WILLIAM F. RYAN, P.E.

CHLOE EUDALY CHIEF ENGINEER STEVE TOWNSEN, P.E.


**BUREAU OF** 

**TRANSPORTATION** 

COMMISSIONER

CITY ENGINEER

6445 SW FALLBROOK PL, STE 100 BEAVERTON, OREGON 97008
TEL: (503) 746-8812
www.emeriodesign.com

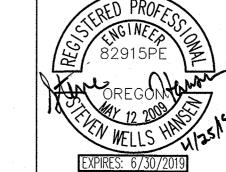

**PUBLIC IMPROVEMENTS** N HUMBOLDT ST WEST OF N GAY AVE

> N HUMBOLDT ST **GRADING PLAN**


BES JOB NO. EP492 PBOT JOB NO. TH0793 SHEET NO.


#### STORMWATER FACILITY NOTES


- STORMWATER FACILITY CONSTRUCTION TO BE INSPECTED BY BES CONSTRUCTION INSPECTOR.
- CONTRACTOR SHALL CONTACT BES CONSTRUCTION 48-HOURS PRIOR TO STARTING CONSTRUCTION ON THE STORMWATER FACILITY. ANY WORK ON THE FACILITY WITHOUT INSPECTIONS WILL BE
- CONTRACTOR SHALL PROVIDE BES CONSTRUCTION WITH TESTING DATA AS PER CITY OF PORTLAND STANDARD SPECIFICATIONS SECTION 01040.13—SOIL TESTING 14 DAYS PRIOR TO CONSTRUCTION.
- SEE CITY OF PORTLAND STANDARD CONSTRUCTION SPECIFICATIONS SECTION 01040.14(d) STORMWATER FACILITY TOPSOIL.
- INSTALL TOPSOIL IN A MANNER THAT ENSURES ADEQUATE INFILTRATION. PLACE IN TWO EQUAL LIFTS. LIFTS SHOULD NOT BE COMPACTED, BUT RATHER PLACED IN A MANNER TO REDUCE EXCESSIVE EROSION OR SETTLEMENT. LIFTS MAY BE LIGHTLY WATERED TO ENCOURAGE NATURAL COMPACTION OR, IF NECESSARY ROLLED WITH A WATER-FILLED LANDSCAPE ROLLER. SLIGHTLY OVERFILL THE FACILITY ABOVE PROPOSED FINISHED GRADE TO ACCOMMODATE NATURAL
- AFTER THE STORMWATER FACILITY CONSTRUCTION STARTS, THE BES INSPECTOR IS REQUIRED TO CHECK ON THE PROGRESS OF THE JOB AS NECESSARY UNTIL THE FACILITY HAS BEEN PLANTED. CONSTRUCTION DELAY WILL RESULT IN ADDITIONAL FEES.
- FOLLOWING SWALE CONSTRUCTION, PLANTING SHALL OCCUR BETWEEN SEPTEMBER 1 AND NOVEMBER 1, OR BETWEEN FEBRUARY 1 AND APRIL 15. IF CONSTRUCTION IS COMPLETED DURING THESE TIME PERIODS, PLANTING SHALL OCCUR IMMEDIATELY. IF CONSTRUCTION IS COMPLETED OUTSIDE OF THESE PERIODS, TOPSOIL SHALL BE COVERED ENTIRELY WITH NORTH AMERICAN GREEN C125BN EROSION CONTROL FABRIC, SECURED WITH 12" WOODEN ECOSTAKE (18" ON-CENTER). PLANTS SHALL BE INSTALLED THROUGH HOLES CUT IN THE EROSION CONTROL FABRIC, AND FABRIC SHALL BE RESTAKED SECURELY FOR STABILITY AND SOIL COVERAGE FOLLOWING PLANTING.
- CONTRACTOR TO PLACE EROSION CONTROL FABRIC OVER STORMWATER FACILITY TO PREVENT EROSION DURING WET WEATHER CONDITIONS. FABRIC SHALL BE 100% BIODEGRADABLE COIR FABRIC (NORTH AMERICAN C125BN OR APPROVED EQUAL).
- PLANTS SHALL BE INSPECTED AND APPROVED BY BES REVEGETATION PROGRAM PRIOR TO PLANTING. CONTACT THE BES PUBLIC WORKS INSPECTOR.

WEST PLANTER SPOT GRADE TABLE						
NUMBER	STREET STATION	ELEVATION & DESCRIPTION	ELEVATION & DESCRIPTION	ELEVATION & DESCRIPTION		
1	1+24.00, 15.00'LT N HUMBOLDT ST	190.63 G	191.13 TC			
2	1+24.75, 15.00'LT N HUMBOLDT ST	190.64 G	190.47 DG			
3	1+35.75, 15.00'LT N HUMBOLDT ST	190.79 G	190.62 DG			
4	1+36.50, 15.00'LT N HUMBOLDT ST	190.80 G	191.30 TC			
5	1+24.00, 20.25'LT N HUMBOLDT ST	189.88 FG	191.46 TW			
6	1+36.50, 20.25'LT N HUMBOLDT ST	190.05 FG	191.63 TW			
7	1+24.00, 23.50'LT N HUMBOLDT ST	189.88 FG	191.46 TW	191.13 SW		
8	1+24.17, 23.50'LT N HUMBOLDT ST	191.05 DN	191.13 SW			
9	1+30.50, 23.50'LT N HUMBOLDT ST	191.14 DN	191.22 SW			
10	1+36.50, 23.50'LT N HUMBOLDT ST	190.05 FG	191.63 TW	191.30 SW		

EAST PLANTER SPOT GRADE TABLE						
NUMBER	STREET STATION	ELEVATION & DESCRIPTION	ELEVATION & DESCRIPTION	ELEVATION & DESCRIPTION	ELEVATION & DESCRIPTION	
11	1+77.50, 15.00'LT N HUMBOLDT ST	190.63 G	191.13 TC			
12	1+78.25, 15.00'LT N HUMBOLDT ST	190.64 G	190.47 DG	1		
13	1+84.75, 15.00'LT N HUMBOLDT ST	190.68 G	191.18 TC			
14	1+92.25, 15.00'LT N HUMBOLDT ST	190.74 G	191.24 TC			
15	1+98.75, 15.00'LT N HUMBOLDT ST	190.78 G	190.61 DG			
16	1+99.50, 15.00'LT N HUMBOLDT ST	190.79 G	191.29 TC			
17	1+77.50, 20.25'LT N HUMBOLDT ST	189.88 FG	191.46 TW			
18	1+84.75, 20.25'LT N HUMBOLDT ST	189.93 FG	190.68 TD		:	
19	1+92.25, 20.25'LT N HUMBOLDT ST	189.99 FG	190.74 TD			
20	1+99.50, 20.25'LT N HUMBOLDT ST	190.04 FG	191.62 TW			
21)	1+77.50, 23.50'LT N HUMBOLDT ST	189.88 FG	191.46 TW	191.13 SW		
22	1+77.67, 23.50'LT N HUMBOLDT ST	191.05 DN	191.13 SW			
23	1+84.75, 23.50'LT N HUMBOLDT ST	189.93 FG	190.68 TD	191.51 TW	191.18 SW	
24	1+85.17, 23.50'LT N HUMBOLDT ST	191.11 DN	191.19 SW			
25	1+92.25, 23.50'LT N HUMBOLDT ST	189.99 FG	190.74 TD	191.57 TW	191.24 SW	
26	1+92.67, 23.50'LT N HUMBOLDT ST	191.16 DN	191.24 SW			
27	1+99.50, 23.50'LT N HUMBOLDT ST	190.04 FG	191.62 TW	191.41 SW		

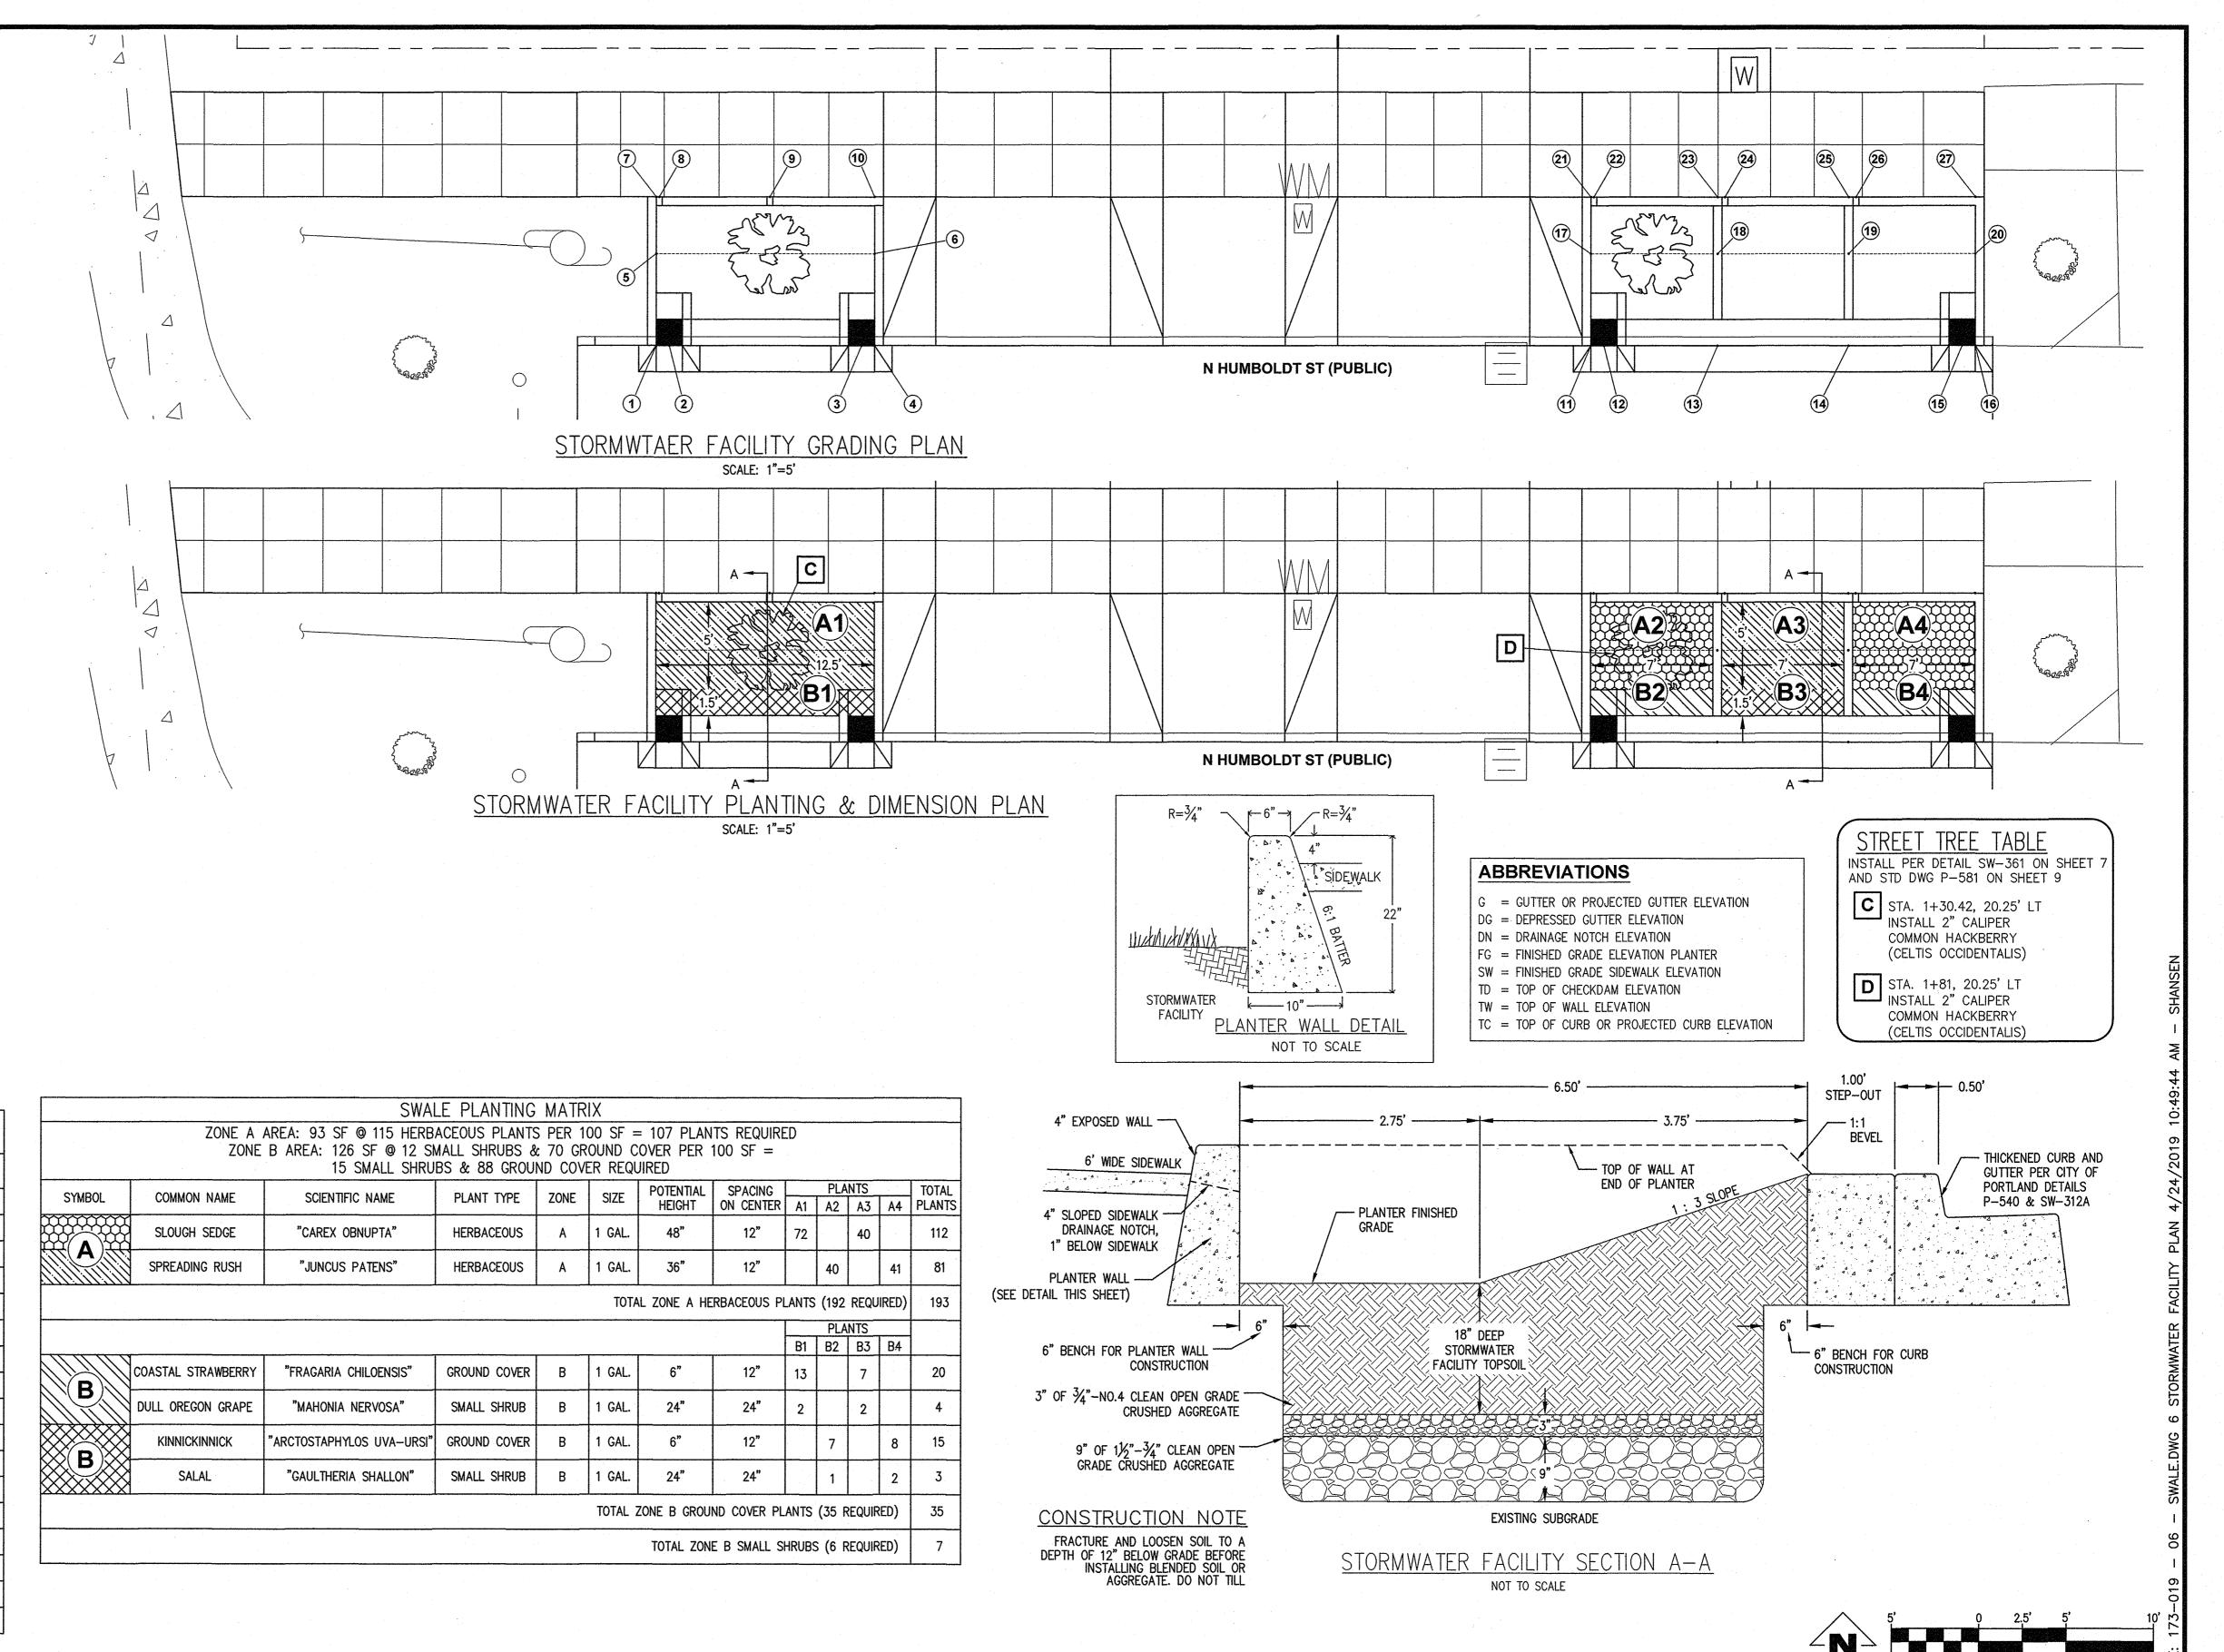

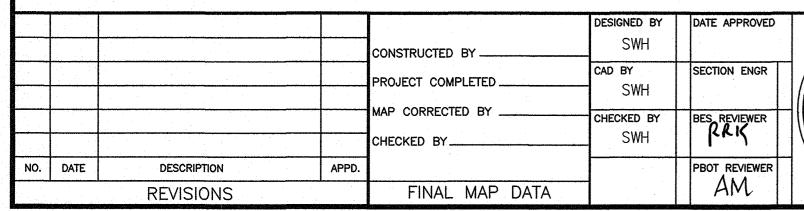

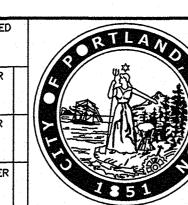

**APPROVALS:** REG. PROF. ENGR. 75155PE

PBOT CITY ENGINEER

5/13/19 REG. PROF. ENGR. 16301PE NICK FISH

REG. PROF. ENGR. 51538PE

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**PUBLIC IMPROVEMENTS** N HUMBOLDT ST WEST OF N GAY AVE


STORMWATER FACILITY PLAN


PBOT JOB NO. TH0793 SHEET NO.

BES JOB NO.

EP492

SCALE: 1'' = 5'

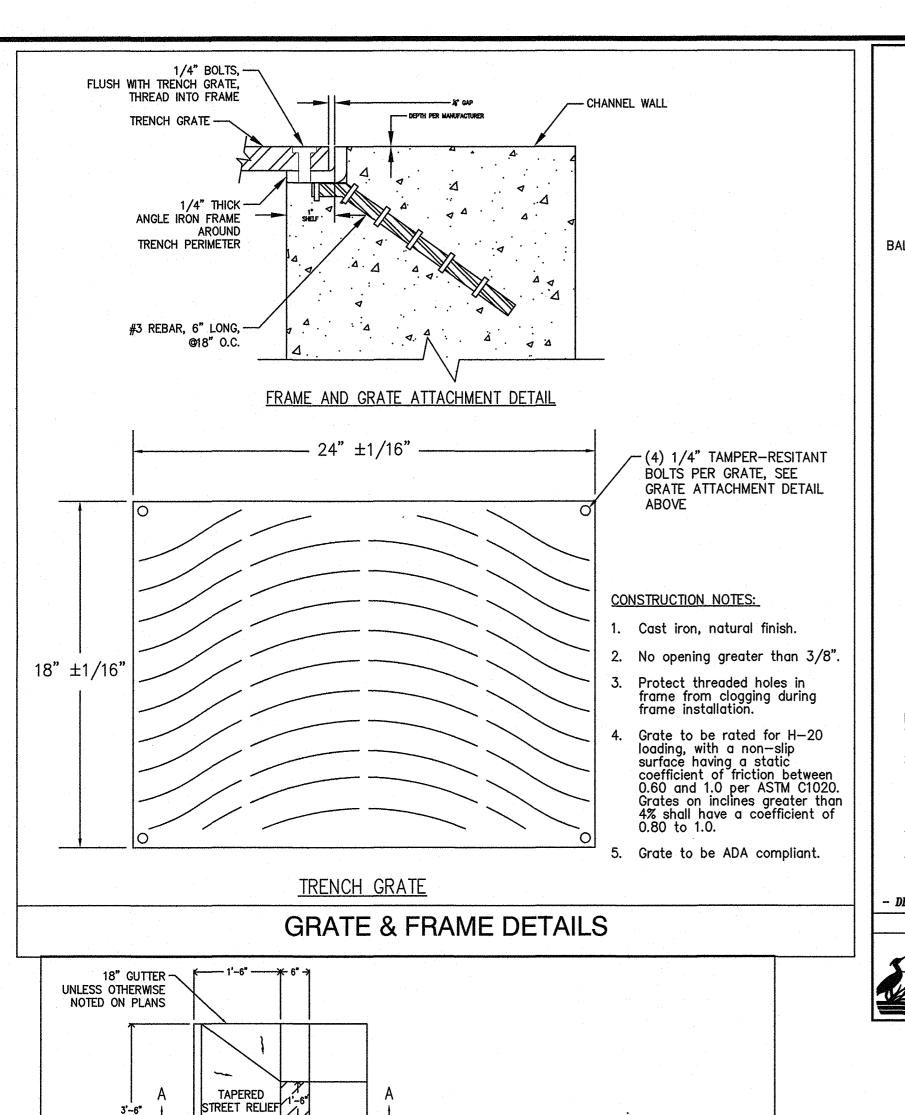

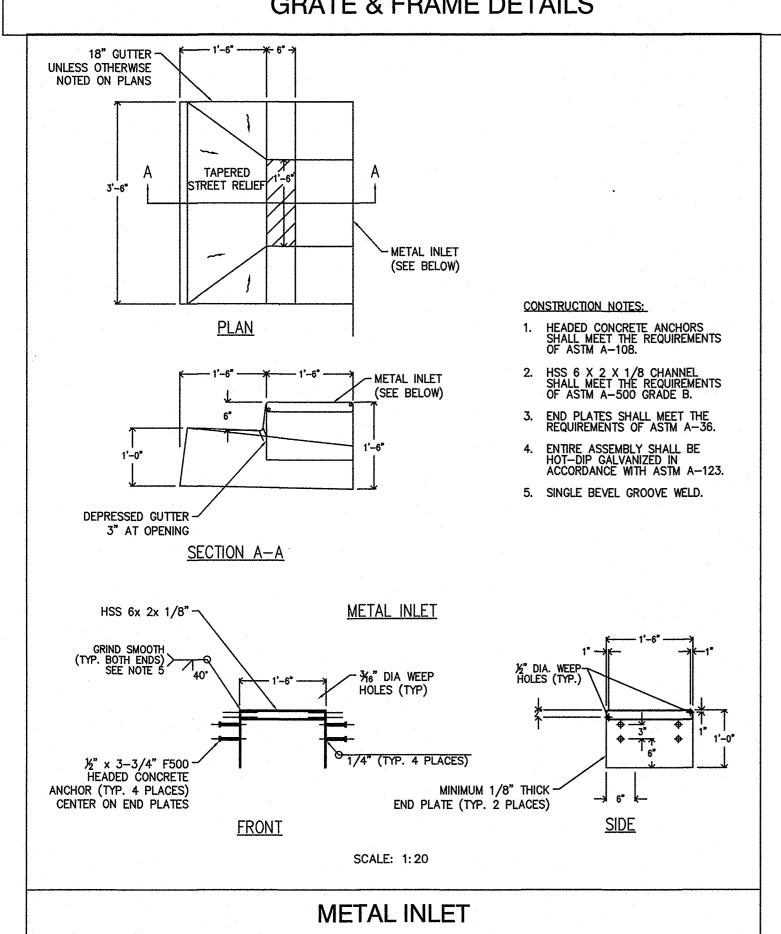


CHECKED BY

FINAL MAP DATA

NO. DATE

DESCRIPTION

REVISIONS

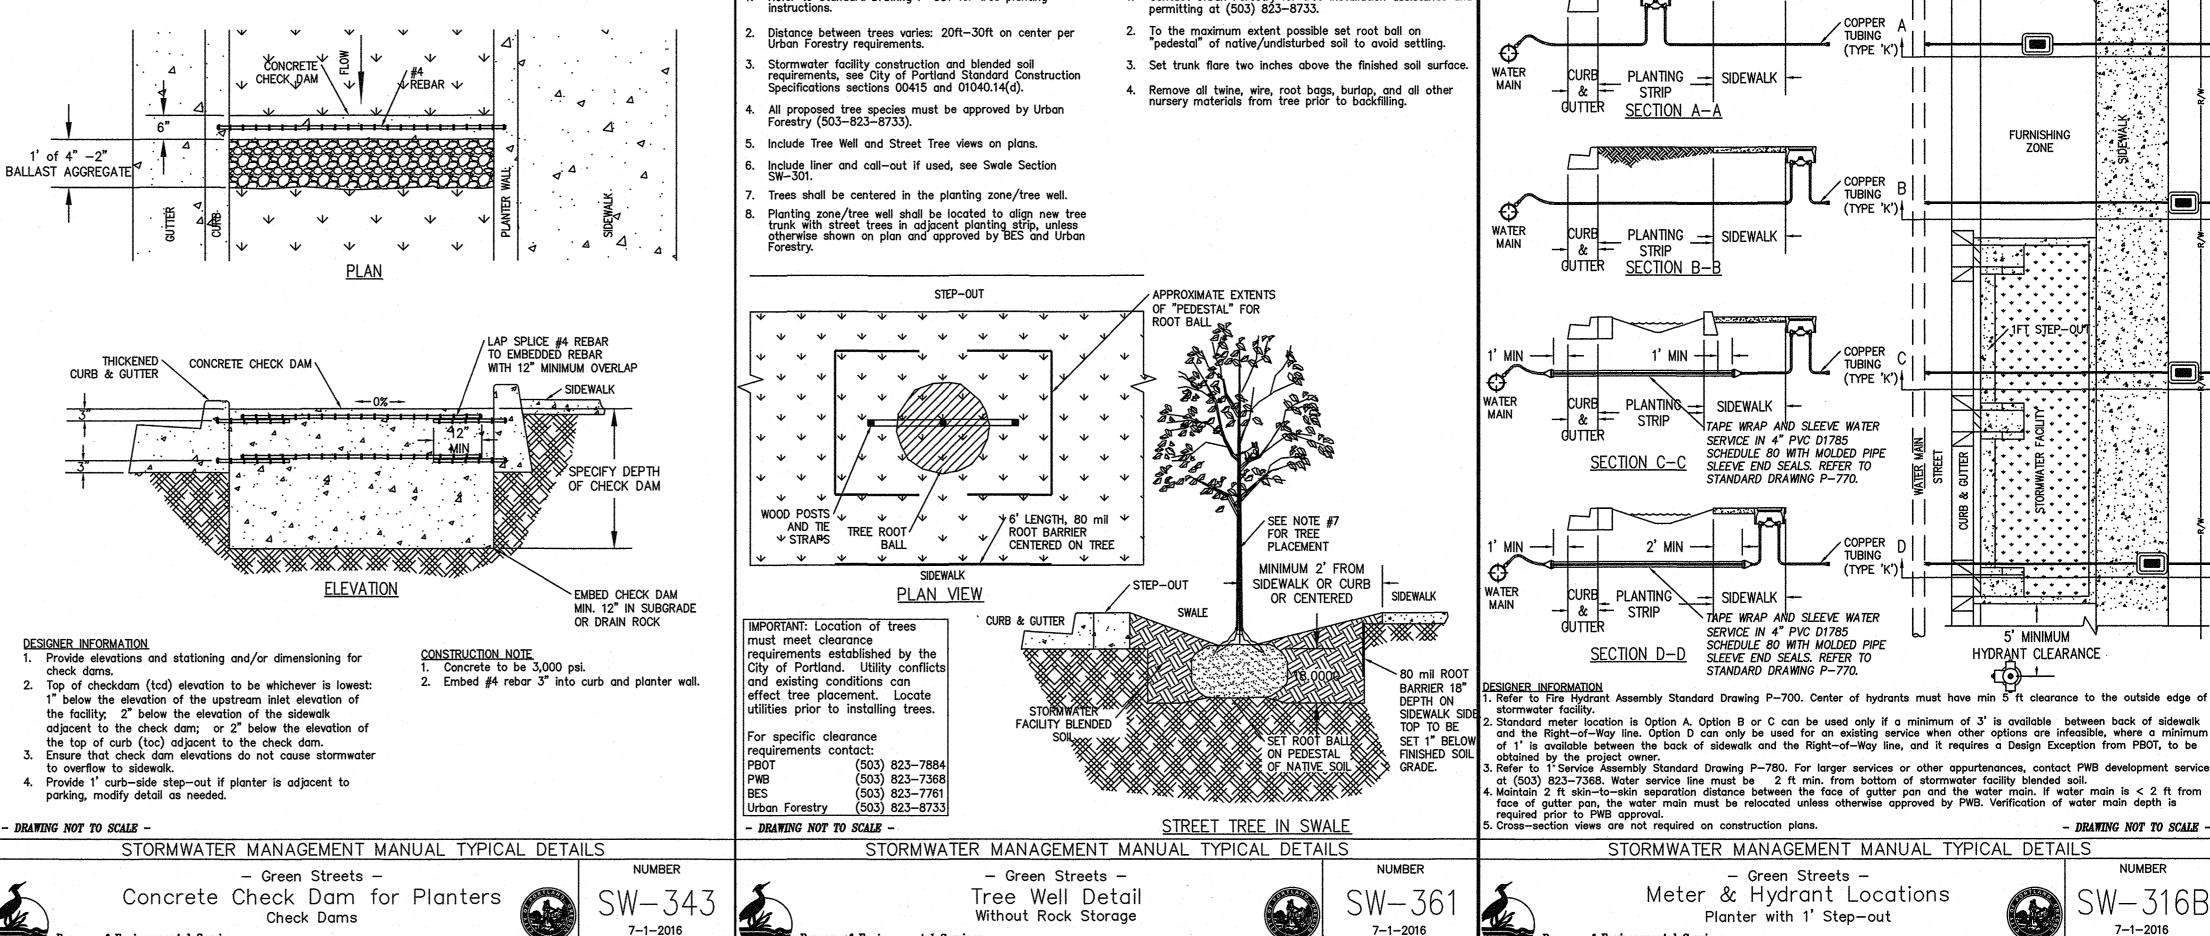



DESIGNER INFORMATION:

Refer to Standard Drawing P-581 for tree plantina

CONSTRUCTION NOTES:

Contact Urban Forestry for tree installation assistance and

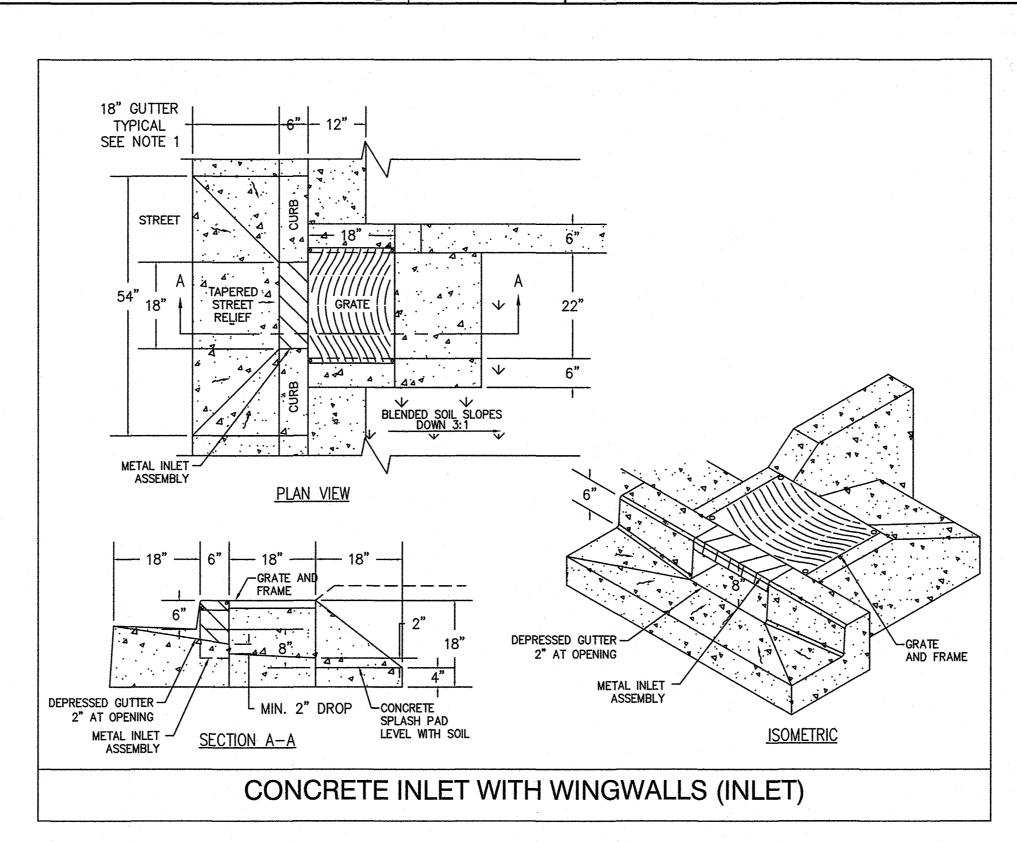

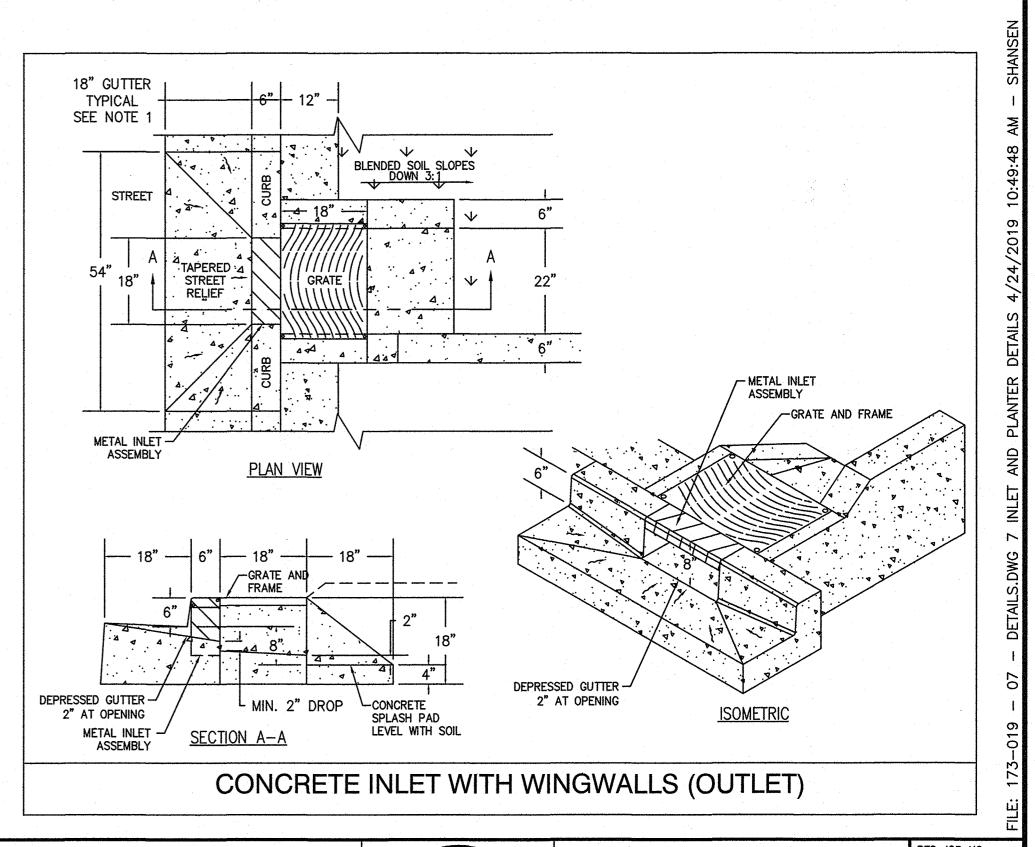

TUBING (TYPE 'K')

TUBING

(TYPE 'K')

(TYPE 'K')

SERVICE IN 4" PVC D1785 SCHEDULE 80 WITH MOLDED PIPE SLEEVE END SEALS. REFER TO

STANDARD DRAWING P-770.

SIDEWALK TAPE WRAP AND SLEEVE WATER

SCHEDULE 80 WITH MOLDED PIPE SLEEVE END SEALS. REFER TO

- Green Streets -

Meter & Hydrant Locations

Planter with 1' Step-out

SERVICE IN 4" PVC D1785

**FURNISHING** 

ZONE

ンJFT SJEP-QUT


5' MINIMUM

HYDRANT CLEARANCE

- DRAWING NOT TO SCALE

NUMBER

7-1-2016

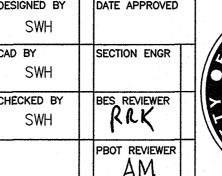

SWH

APPROVALS: BOT CITY ENGINEER

**BUREAU OF ENVIRONMENTAL SERVICES** 

5/13/19 REG. PROF. ENGR. 16301PE

REG. PROF. ENGR. 75155PE

REG. PROF. ENGR. 51538PE

5/14/19

NICK FISH COMMISSIONER WILLIAM F. RYAN, P.E.

**BUREAU OF TRANSPORTATION** 

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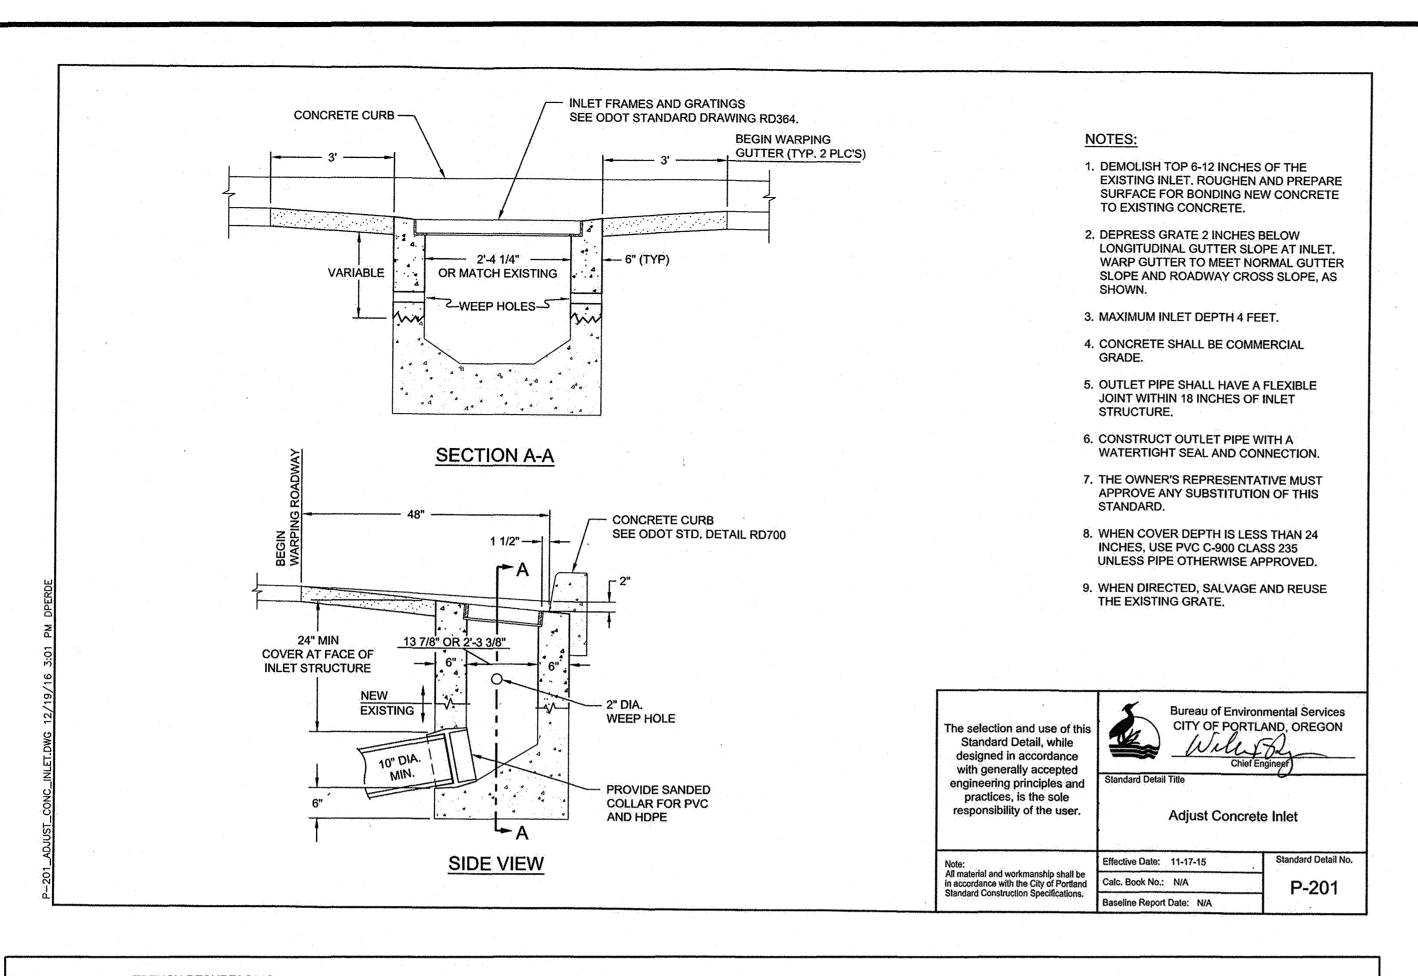



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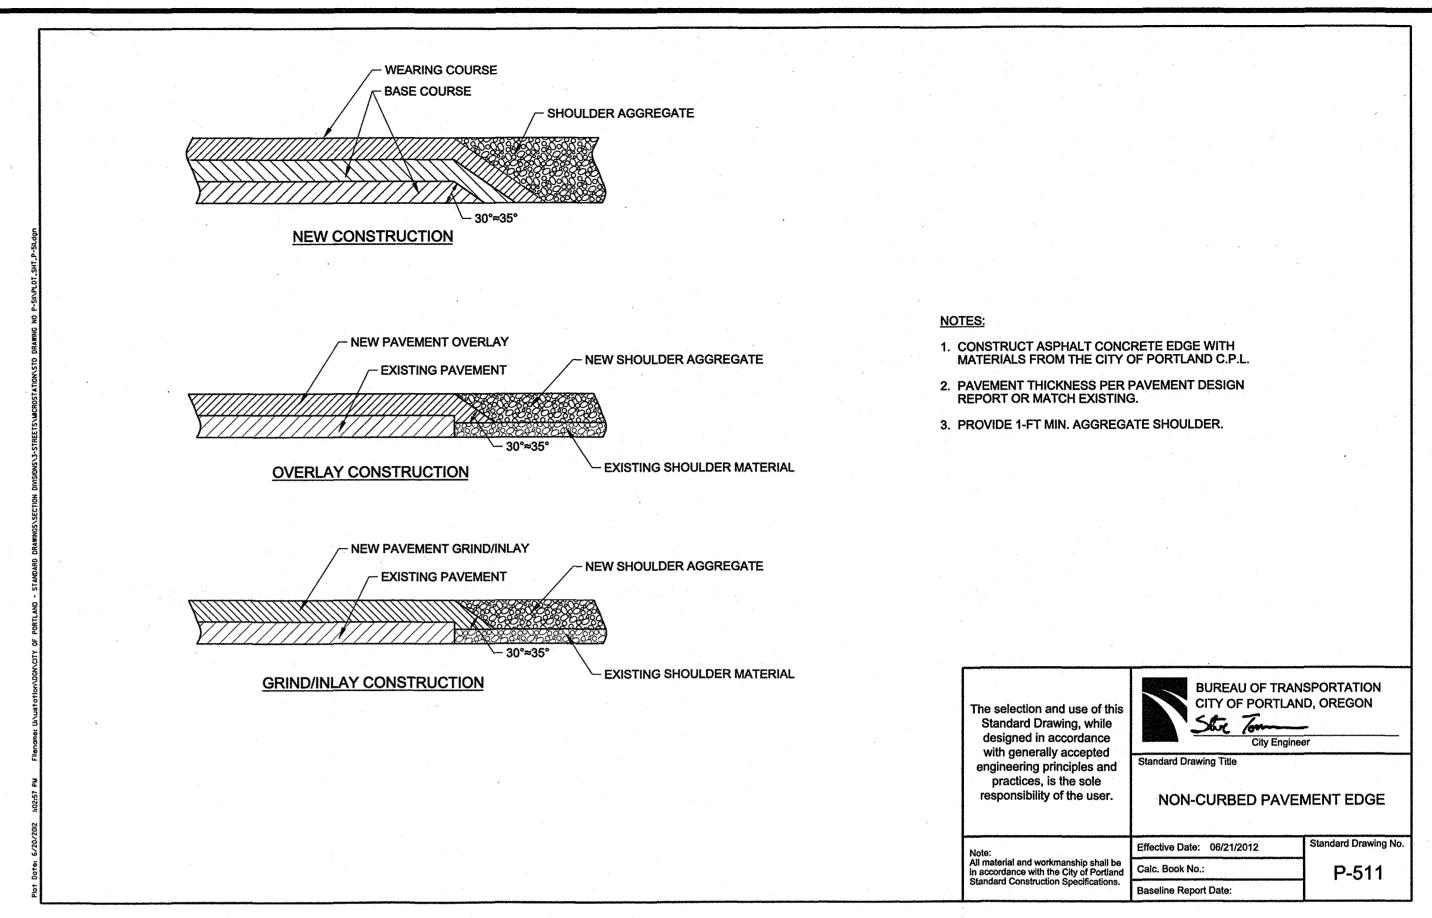
> **INLET AND PLANTER DETAILS**


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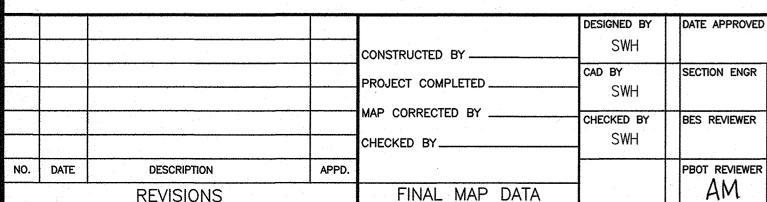
EP492








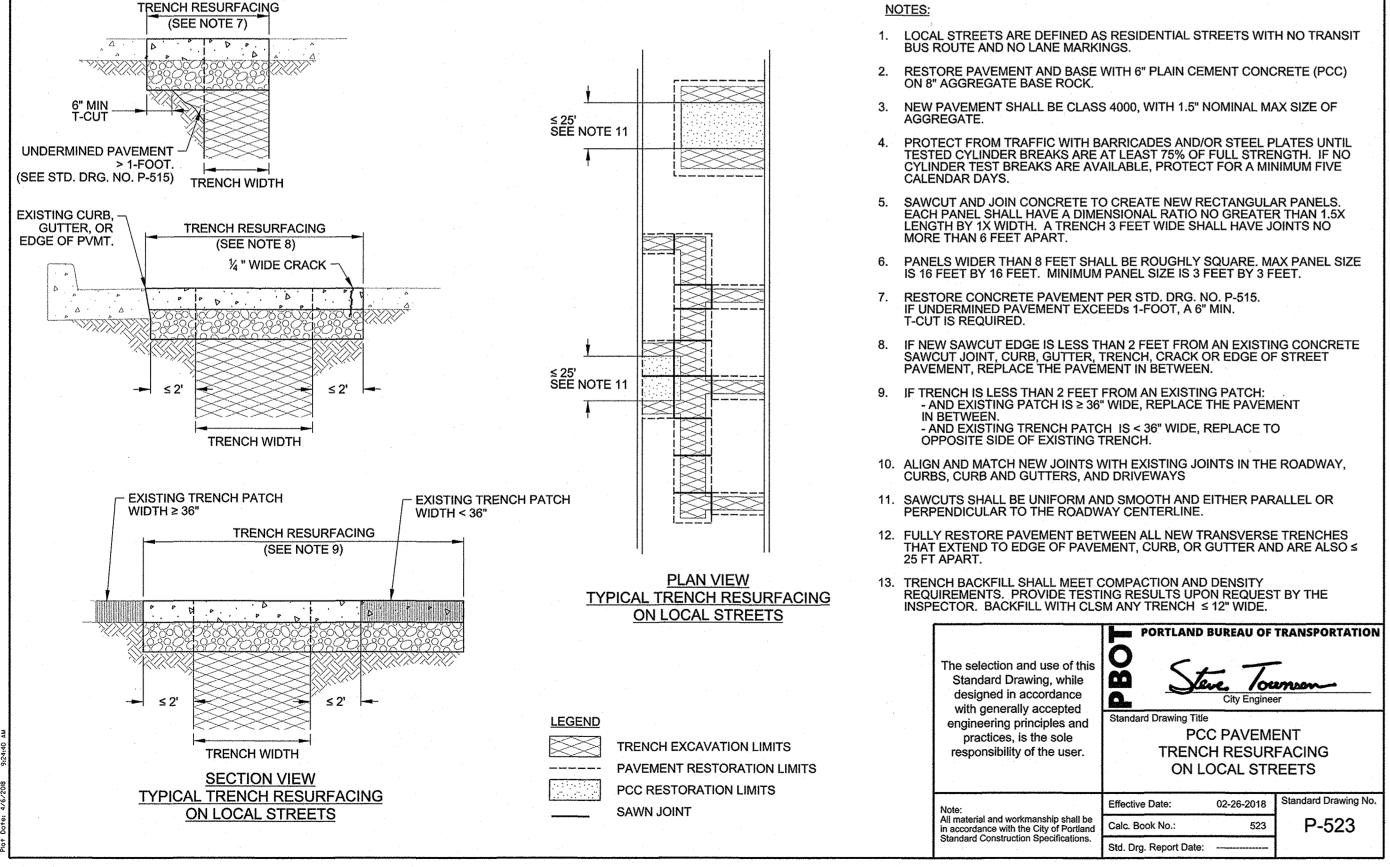

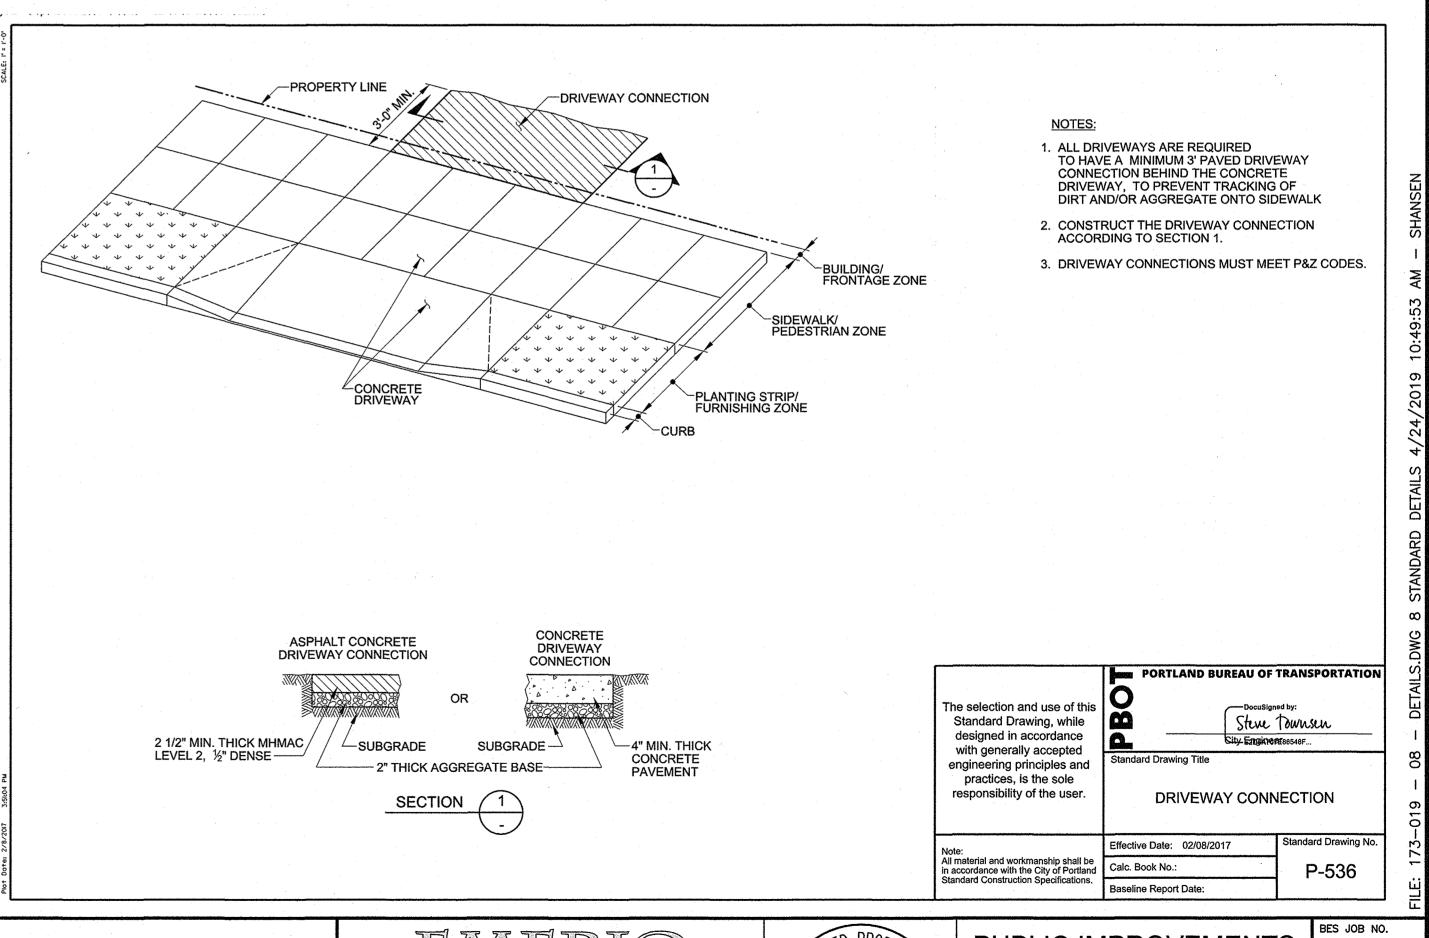

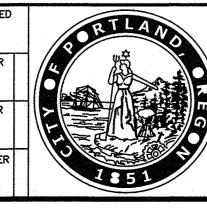

APPROVALS: REG. PROF. ENGR. 16301PE MM W-INCIPAL ENGINEER REG. PROF. ENGR. 75155PE PBOT CITY ENGINEER REG. PROF. ENGR. 51538PE

**BUREAU OF** ENVIRONMENTAL SERVICES

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**BUREAU OF TRANSPORTATION** 

COMMISSIONER CITY ENGINEER





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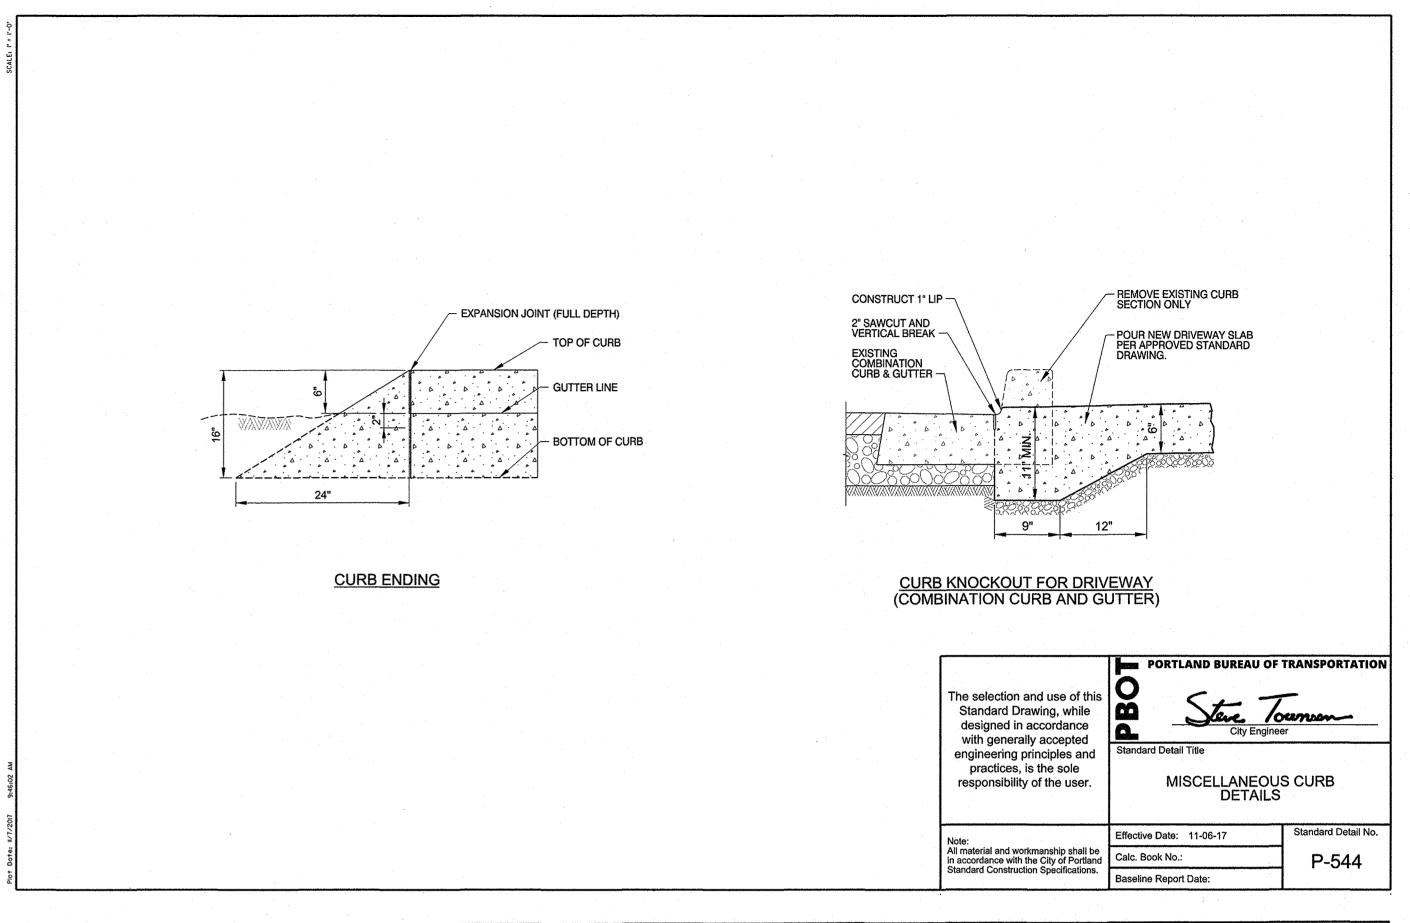
STANDARD DETAILS


PBOT JOB NO. TH0793 SHEET NO.


**EP492** 



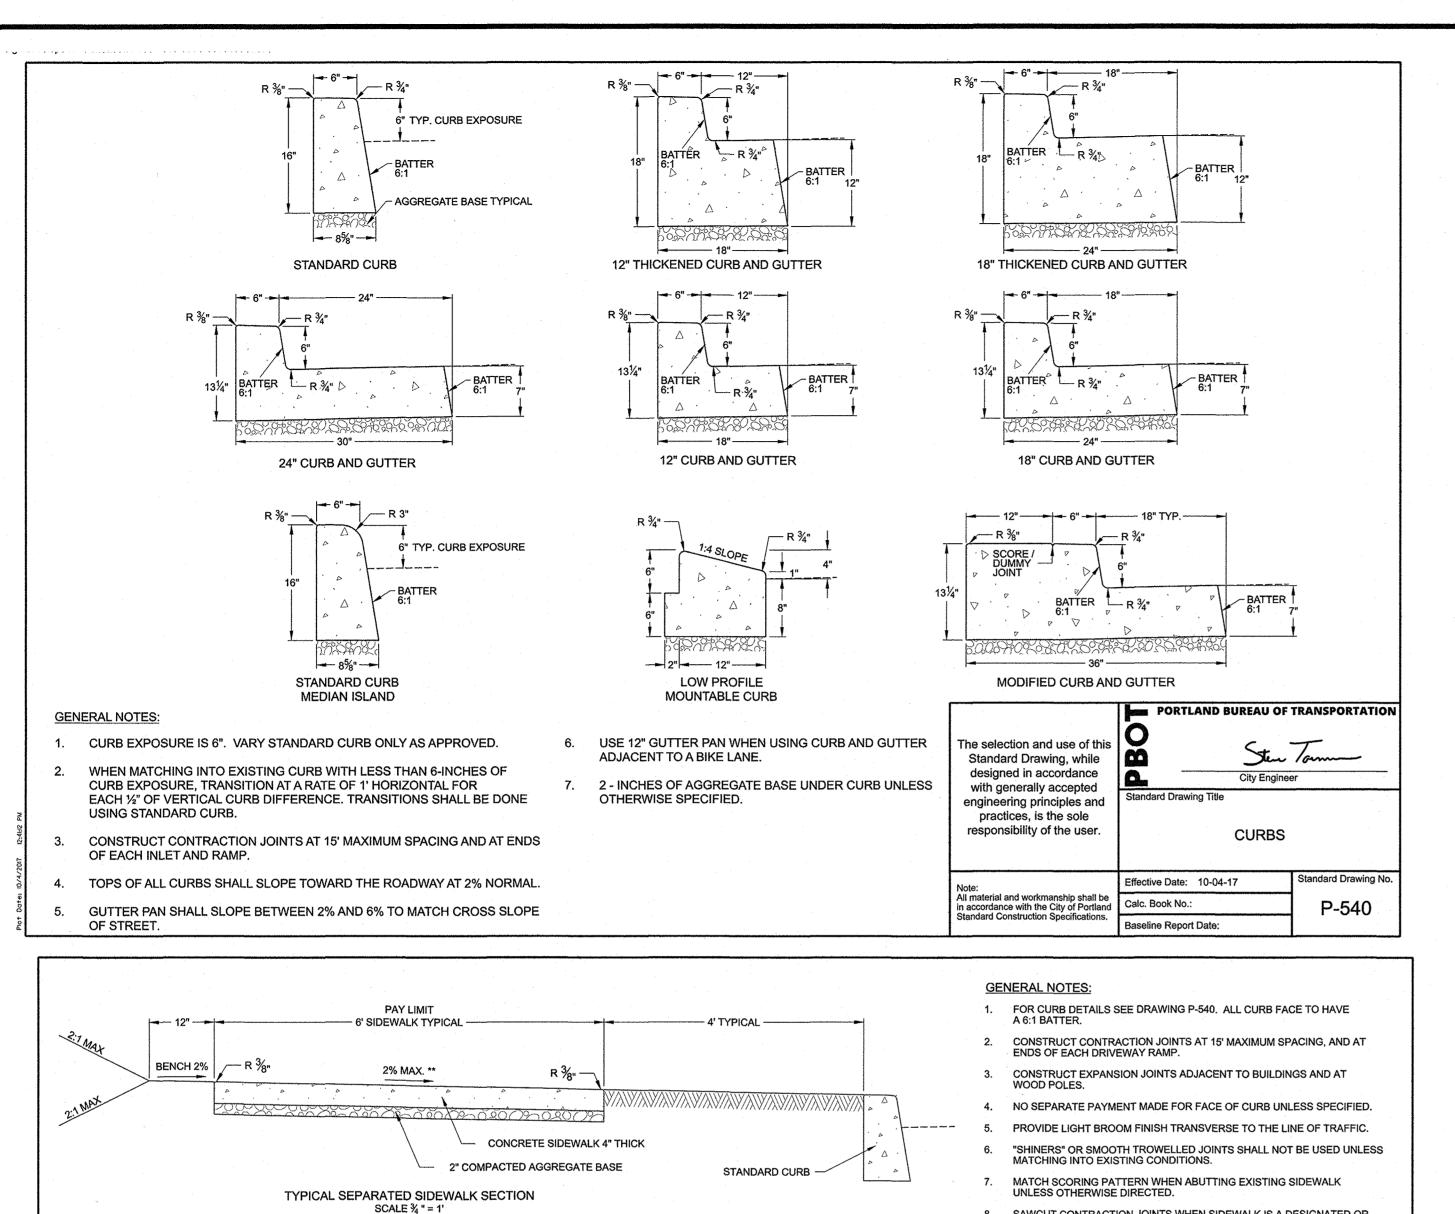


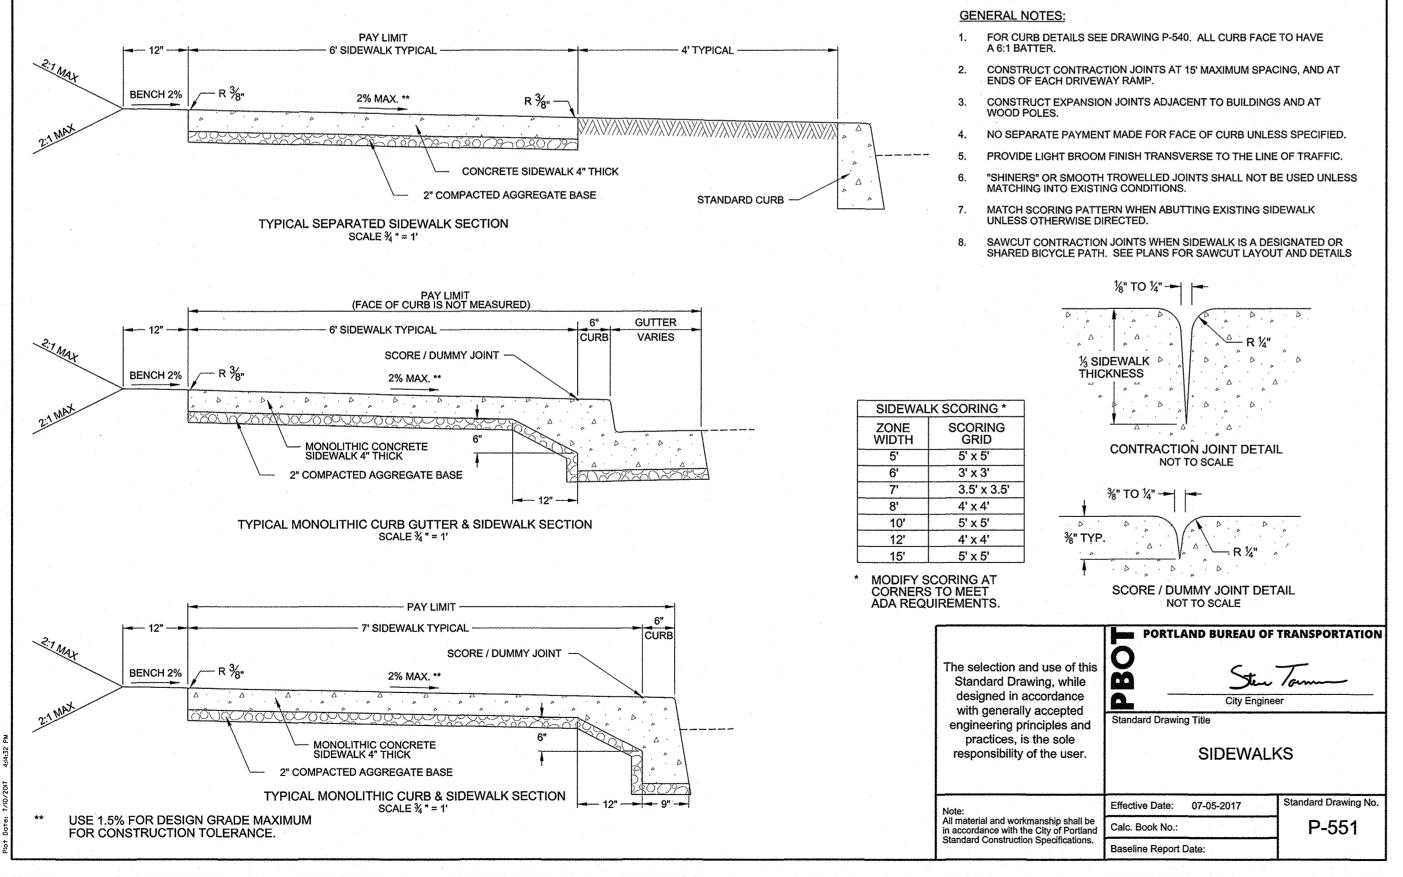

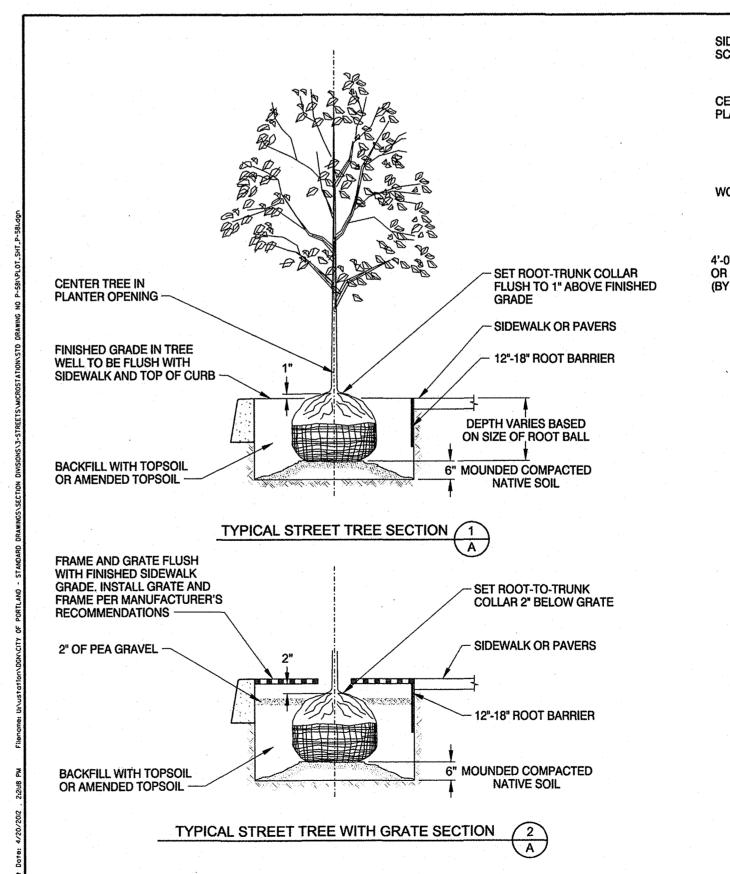

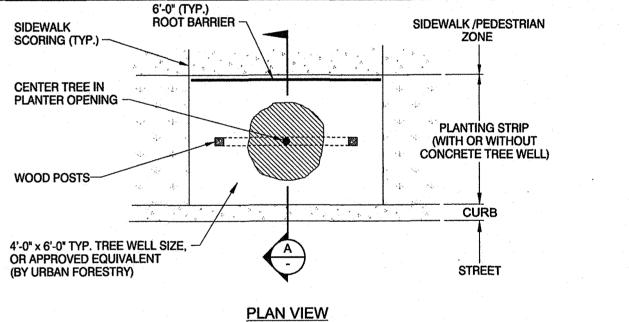

- 1. EXCAVATE 2½ TIMES THE SIZE OF ROOT BALL OR TREE WELL DIMENSIONS.
- 2. CAREFULLY REMOVE AS MUCH OF BURLAP AND BASKET AS POSSIBLE WITHOUT CAUSING DAMAGE TO ROOTBALL.
- TREE GRATES ARE NOT PREFERRED AND SUBJECT TO APPROVAL. IF USED TREE GRATES MUST BE ADA COMPLIANT. USE PRODUCTS ON CPL OR AS APPROVED BY URBAN FORESTRY.
- 4. WOOD POSTS WITH APPROVED TIE STRAPS MAY BE NECESSARY FOR TREE STABILITY. INSTALL PARALLEL TO CURB.
- 5. WHEN PLANTING NEAR STREET LIGHTING, SIGNAGE AND OTHER UNDERGROUND UTILITIES, REFER TO URBAN FORESTRY'S "STREET TREE PLANTING AND ESTABLISHMENT GUIDELINES".
- CONTACT URBAN FORESTRY @ (503) 823-4489 FOR FURTHER INFORMATION. 6. ROOT BARRIER SHALL BE USED ALONG SIDEWALK /PEDESTRIAN ZONE SIDE OF STREET TREE. USE PRODUCTS ON CPL OR AS APPROVED BY URBAN FORESTRY.

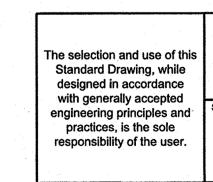

All material and workmanship shall be in accordance with the City of Portland Standard Construction Specifications.

**BUREAU OF TRANSPORTATION** CITY OF PORTLAND, OREGON

> TYPICAL STREET TREE INSTALLATION

Effective Date: 04/20/2012 Calc. Book No.: P-581 Baseline Report Date:

CONSTRUCTED BY SECTION ENGR ROJECT COMPLETED MAP CORRECTED BY CHECKED BY BES REVIEWER CHECKED BY

FINAL MAP DATA

DESCRIPTION

**REVISIONS** 

PBOT REVIEWER

REG. PROF. ENGR. 16301PE RINCIPAL ENGINEER REG. PROF. ENGR. 75155PE REG. PROF. ENGR. 51538PE PBOT CITY ENGINEER

**BUREAU OF** ENVIRONMENTAL SERVICES NICK FISH COMMISSIONER

RYAN, P.E.

**BUREAU OF TRANSPORTATION** 

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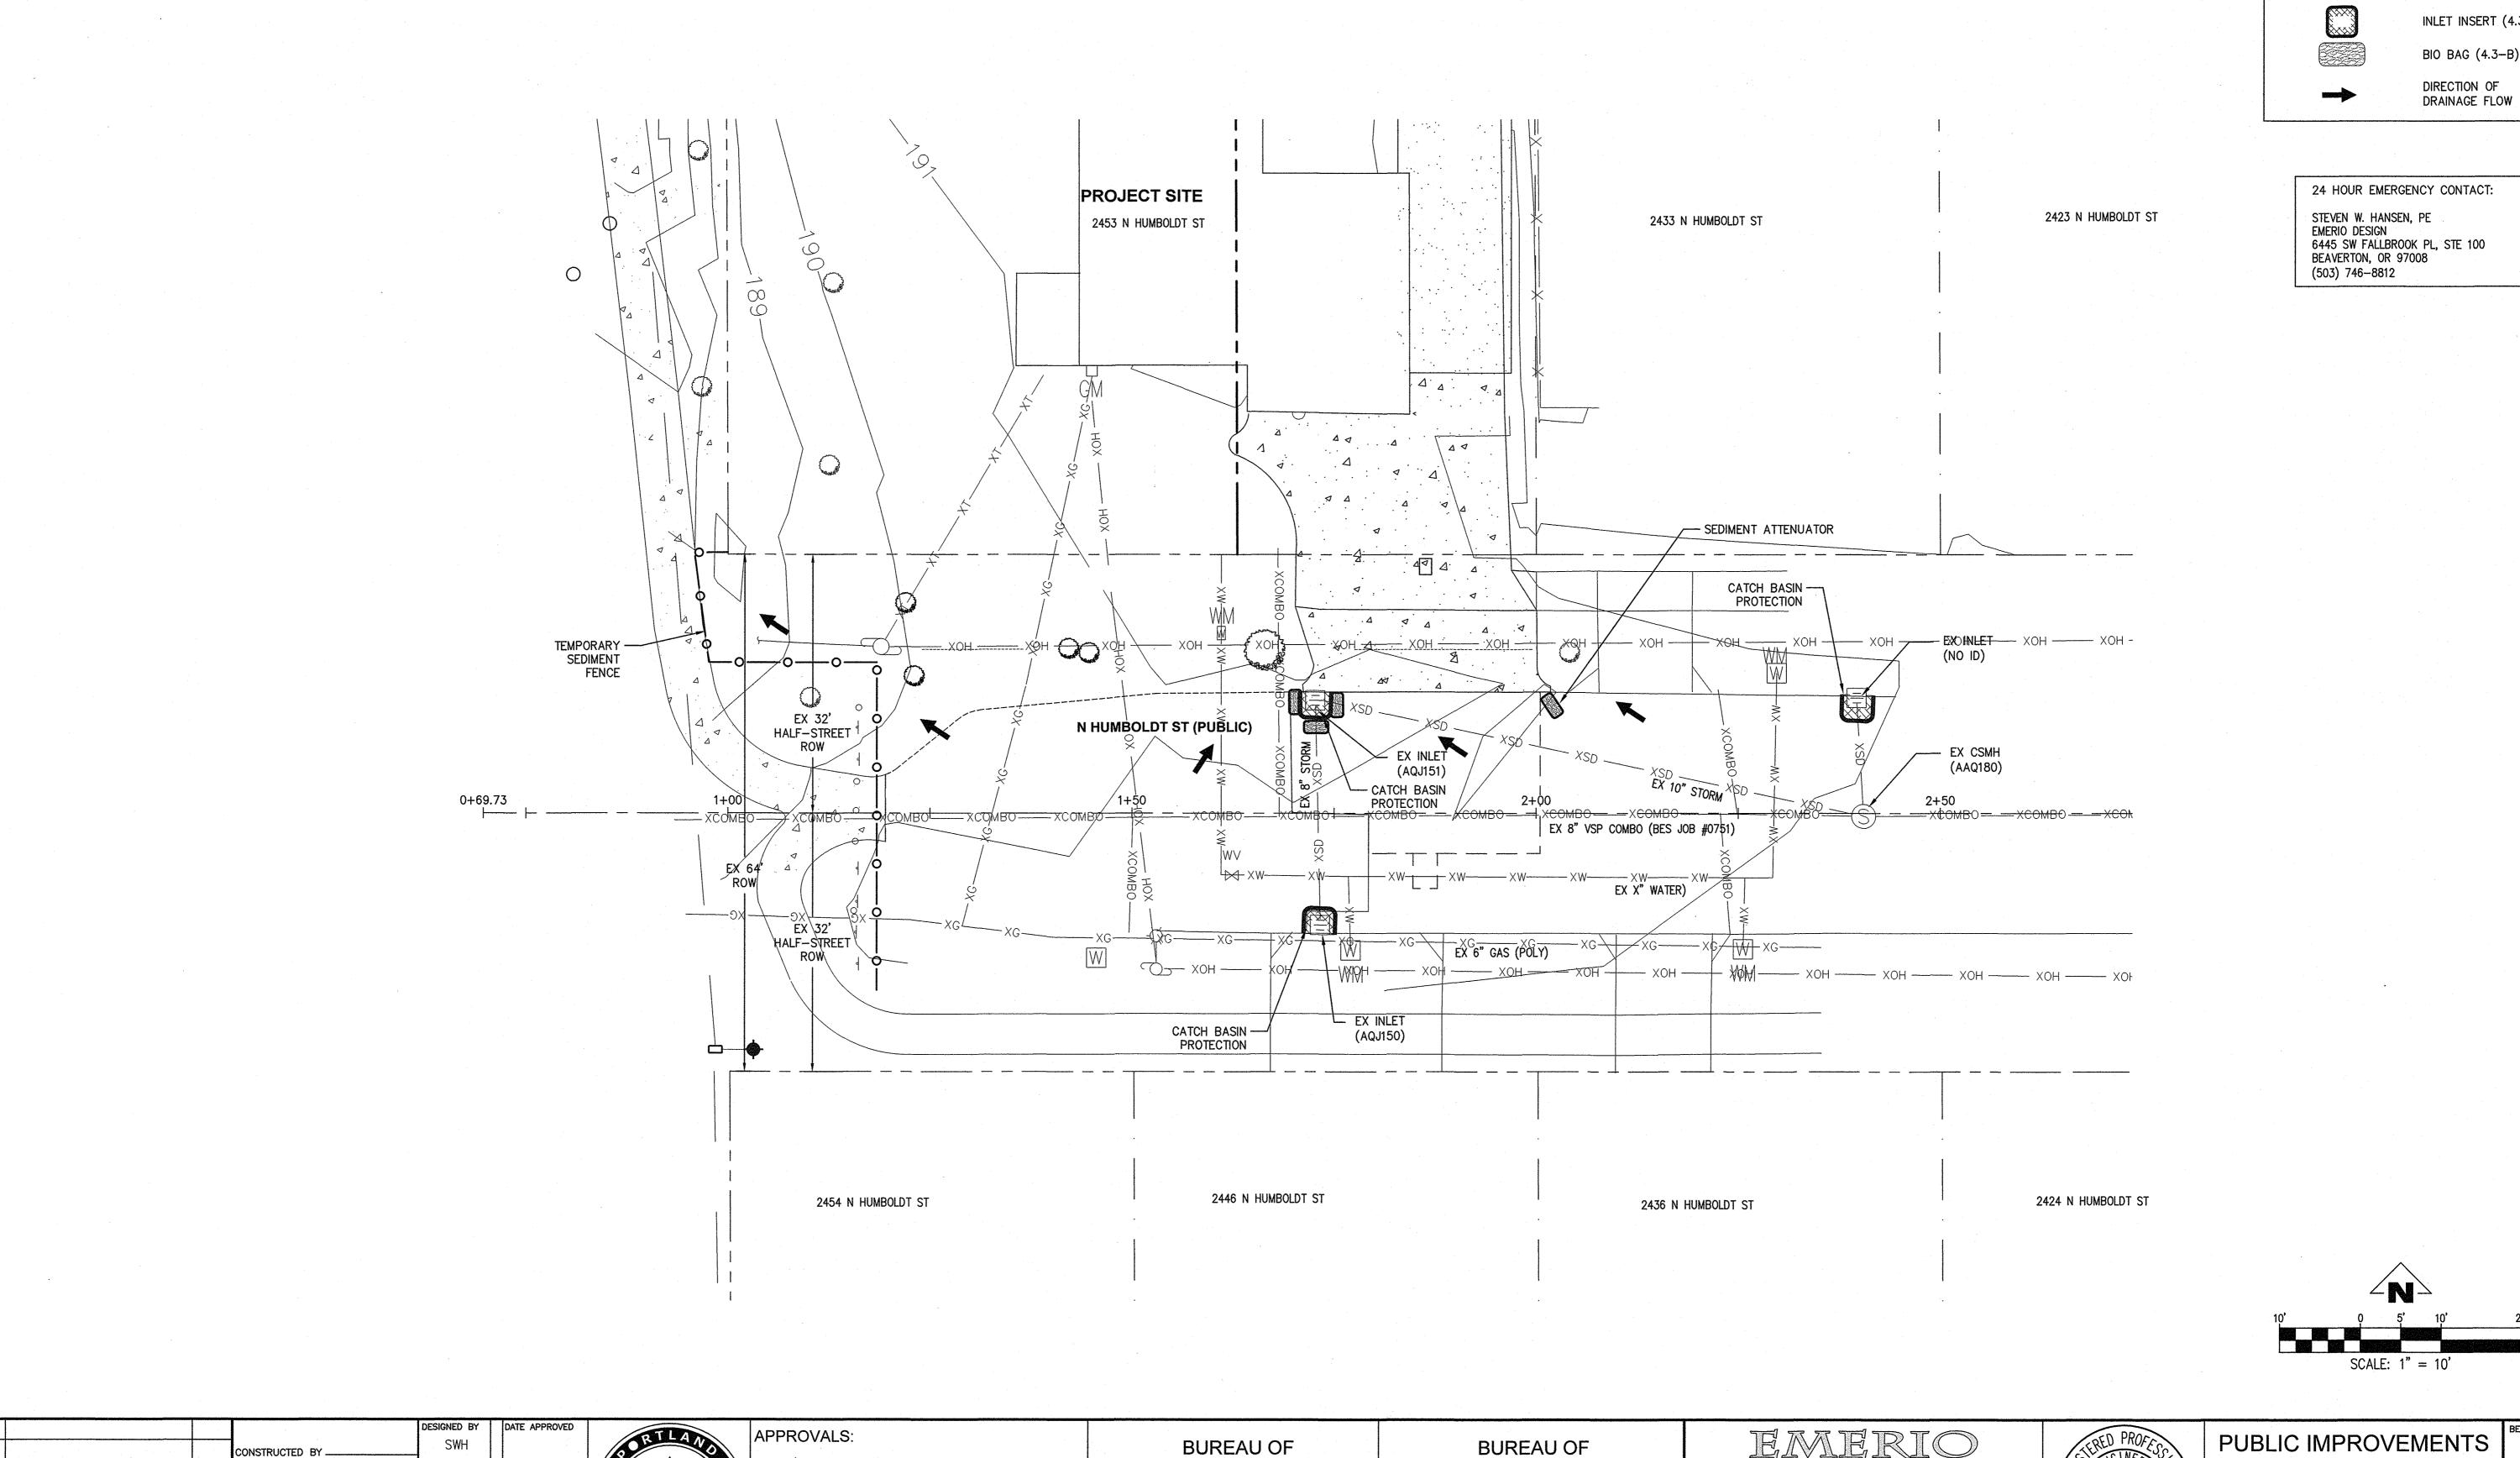
STANDARD DETAILS

TH0793 SHEET NO.

BES JOB NO.

**EP492** 

BOT JOB NO.



**ENVIRONMENTAL SERVICES** 

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CHIEF ENGINEER STEVE TOWNSEN, P.E.

NICK FISH

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**51 H/19**REG. PROF. ENGR. 75155PE

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CONSTRUCTED BY \_

PROJECT COMPLETED.

MAP CORRECTED BY

FINAL MAP DATA

CHECKED BY\_\_\_

DESCRIPTION

REVISIONS

CAD BY

CHECKED BY

SECTION ENGR

BES REVIEWER

PBOT REVIEWER

**LEGEND** 

——O——O—— SILT FENCE (4.3–A)

INLET INSERT (4.3-G)

BIO BAG (4.3-B)

6445 SW FALLBROOK PL, STE 100 BEAVERTON, OR 97008 (503) 746–8812


PUBLIC IMPROVEMENTS N HUMBOLDT ST WEST OF N GAY AVE


> **EROSION CONTROL** PLAN


TH0793 SHEET NO. EC1 of 2

EP492

PBOT JOB NO.

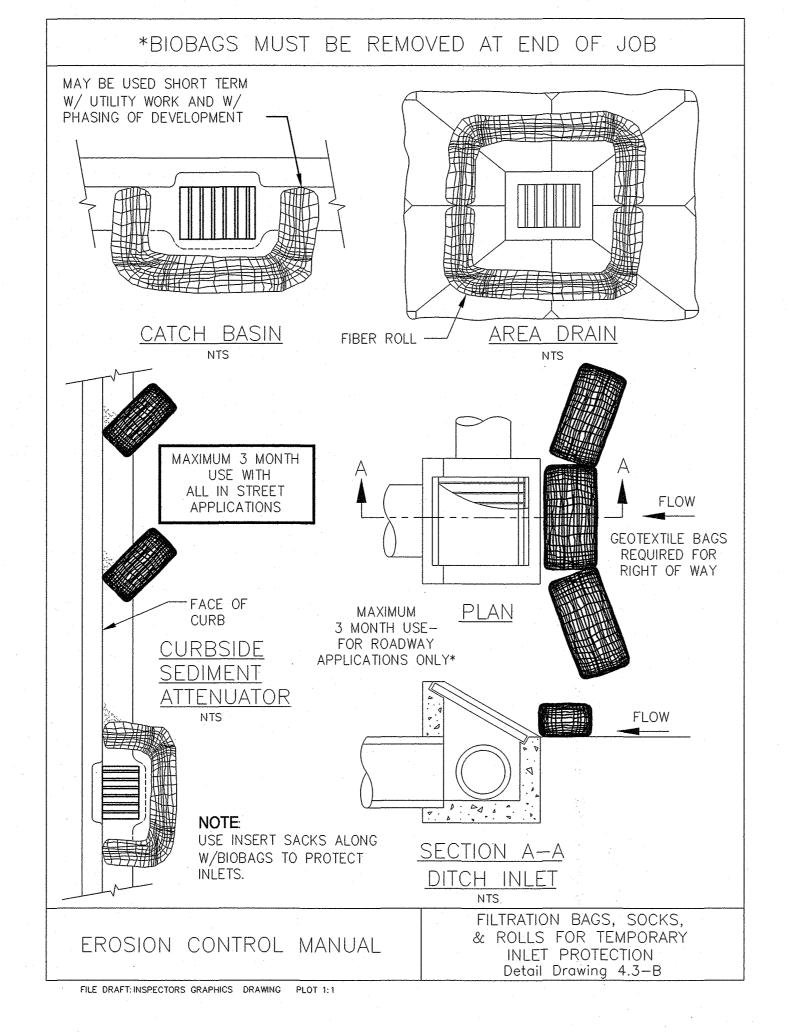

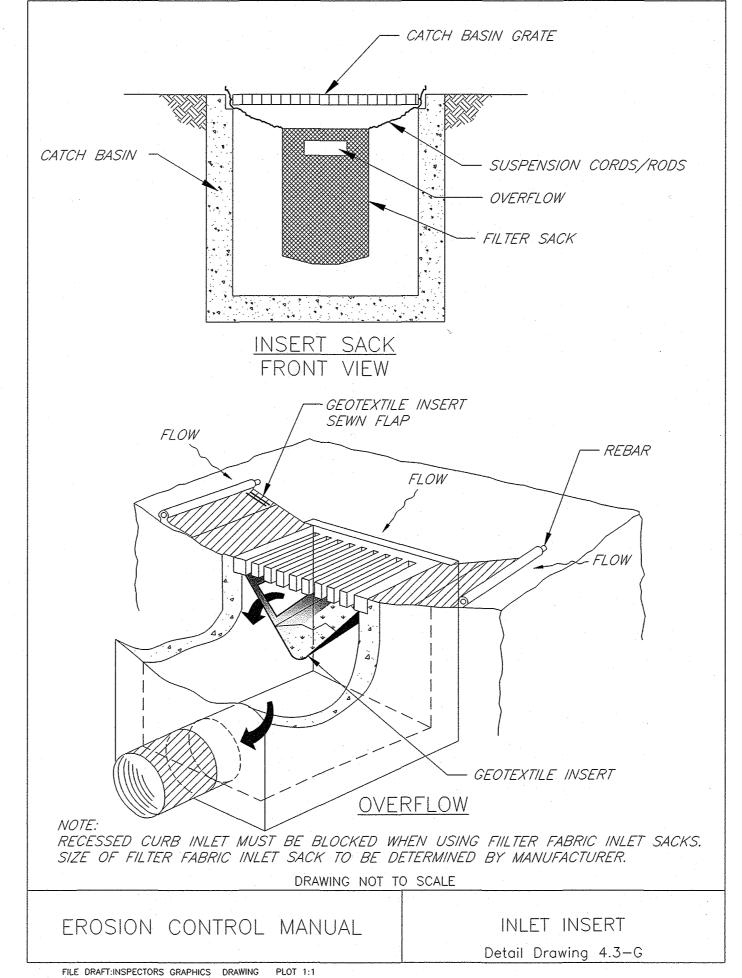

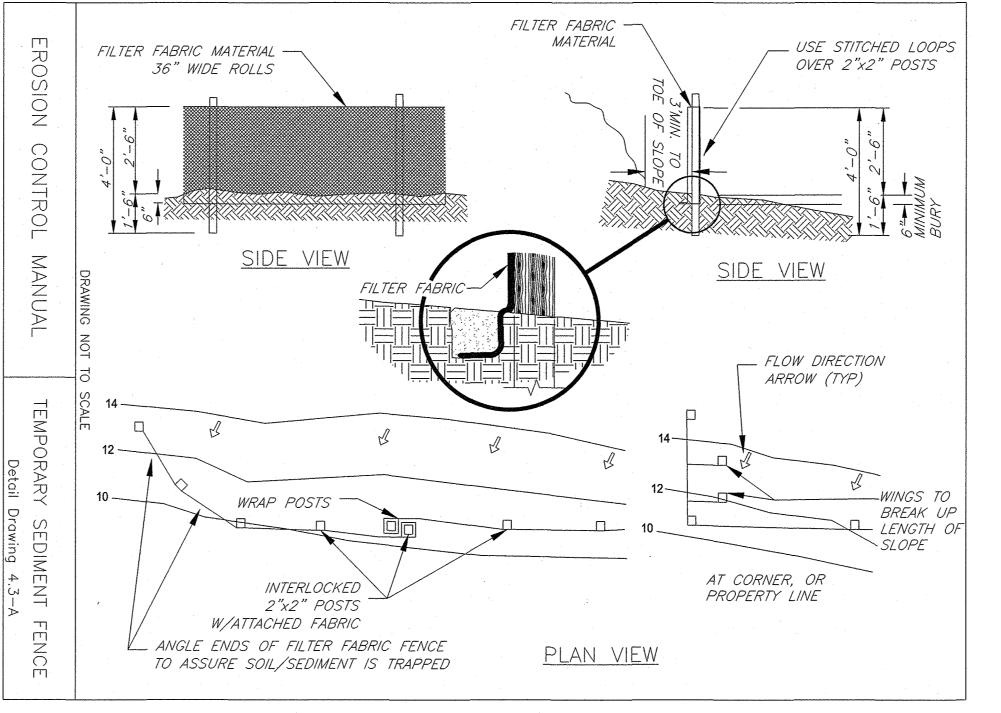

#### **EROSION CONTROL NOTES:**

- APPROVAL OF THIS EROSION SEDIMENT AND POLLUTION CONTROL PLAN (ESPCP) DOES NOT CONSTITUTE AN APPROVAL OF PERMANENT ROAD OR DRAINAGE DESIGN (E.G., SIZE AND LOCATION OF ROADS, PIPES, RESTRICTORS, CHANNELS, RETENTION FACILITIES, UTILITIES, ETC.)
- 2. THE IMPLEMENTATION OF THIS ESPCP AND THE CONSTRUCTION, MAINTENANCE, REPLACEMENT AND UPGRADING OF THESE ESPCP FACILITIES IS THE RESPONSIBILITY OF THE APPLICANT/CONTRACTOR UNTIL ALL CONSTRUCTION IS COMPLETED AND APPROVED, VEGETATION/LANDSCAPING IS ESTABLISHED.
- THE BOUNDARIES OF THE CLEARING LIMITS SHOWN ON THIS PLAN SHALL BE CLEARLY FLAGGED IN THE FIELD PRIOR TO CONSTRUCTION. DURING THE CONSTRUCTION PERIOD, NO DISTURBANCE BEYOND THE FLAGGED CLEARING LIMITS SHALL BE PERMITTED. THE FLAGGING SHALL BE MAINTAINED BY THE APPLICANT/CONTRACTOR FOR THE DURATION OF
- THE ESPCP FACILITIES SHOWN ON THIS PLAN MUST BE CONSTRUCTED IN CONJUNCTION WITH ALL CLEARING AND GRADING ACTIVITIES, AND IN SUCH A MANNER AS TO INSURE THAT SEDIMENT AND SEDIMENT LADEN WATER DO NOT ENTER THE DRAINAGE SYSTEM ROADWAYS OR VIOLATE APPLICABLE WATER STANDARDS.
- 5. THE ESPCP FACILITIES SHOWN ON THIS PLAN ARE THE MINIMUM REQUIREMENTS FOR ANTICIPATED SITE CONDITIONS. DURING THE CONSTRUCTION PERIOD, THESE ESPCP FACILITIES SHALL BE UPGRADED AS NEEDED FOR UNEXPECTED STORM EVENTS, AND TO ENSURE THAT SEDIMENT AND SEDIMENT-LADEN WATER DOES NOT LEAVE THE SITE.
- THE ESPCP FACILITIES SHALL BE INSPECTED DAILY BY THE APPLICANT/CONTRACTOR AND MAINTAINED AS NECESSARY TO ENSURE THEIR CONTINUED FUNCTIONING.
- THE ESPCP FACILITIES ON INACTIVE SITES SHALL BE INSPECTED AND MAINTAINED A MINIMUM OF ONCE A WEEK OR WITHIN THE 24 HOURS FOLLOWING A STORM EVENT.
- STABILIZED CONSTRUCTION ENTRANCES SHALL BE INSTALLED AT THE BEGINNING OF CONSTRUCTION AND MAINTAINED FOR THE DURATION OF THE PROJECT. ADDITIONAL MEASURES MAY BE REQUIRED TO INSURE THAT ALL PAVED AREAS ARE KEPT CLEAN FOR THE DURATION OF THE PROJECT.
- APPLICANT/ CONTRACTOR TO PUT UP ALL REQUIRED EROSION CONTROL SIGNAGE PRIOR TO GROUND DISTURBANCE. A CD WITH ALL REQUIRED EROSION CONTROL SIGNS WILL BE PROVIDED AT THE PRE-CONSTRUCTION MEETING.


#### SEDIMENTATION FENCE NOTES:


- THE FILTER FABRIC FENCE SHALL BE INSTALLED TO FOLLOW THE CONTOURS WHERE FEASIBLE. THE FENCE POSTS SHALL BE SPACED A MAXIMUM OF 6' APART AND DRIVEN SECURELY INTO THE GROUND A MINIMUM OF 24".
- 2. THE FILTER FABRIC SHALL BE PURCHASED IN A CONTINUOUS ROLL CUT TO THE LENGTH OF THE BARRIER TO AVOID USE OF JOINTS. WHEN JOINTS ARE NECESSARY, FILTER CLOTH SHALL BE SPLICED TOGETHER ONLY AT A SUPPORT POST, WITH A MINIMUM 6" OVERLAP, AND BOTH ENDS SECURELY FASTENED TO THE POST, OR OVERLAP 2" X 2" POSTS AND ATTACH AS SHOWN ON DETAIL SHEET 4-3A OF THE EROSION CONTROL MANUAL.
- THE FILTER FABRIC SHALL HAVE A MINIMUM VERTICAL BURIAL OF 6". ALL EXCAVATED MATERIAL FROM FILTER FABRIC 🚽 INSTALLATION SHALL BE BACKFILLED AND COMPACTED ALONG THE ENTIRE DISTURBED AREA.
- 4. STANDARD OR HEAVY-DUTY FILTER FABRIC FENCES SHALL HAVE MANUFACTURED STITCHED LOOPS FOR 2" X 2" POST INSTALLATION. STITCHED LOOPS SHALL BE INSTALLED ON THE UP HILLSIDE OF THE SLOPED AREA.
- FILTER FABRIC FENCES SHALL BE REMOVED WHEN THEY HAVE SERVED THEIR USEFUL PURPOSE, BUT NOT BEFORE THE UPSLOPE AREA HAS BEEN PERMANENTLY PROTECTED AND STABILIZED.
- 6. FILTER FABRIC FENCES SHALL BE INSPECTED BY APPLICANT/CONTRACTOR IMMEDIATELY AFTER EACH RAINFALL AND AT LEAST DAILY DURING PROLONGED RAINFALL. ANY REQUIRED REPAIRS SHALL BE MADE IMMEDIATELY.

#### SIGNAGE NOTES:

SITE EROSION CONTROL PLANS TO BE APPROVED AND CONTROLS IN PLACE PRIOR TO GRADING AND WORKING IN RIGHT-OF-WAY.

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				PROJECT COMPLETED	CAD BY SWH	SECTION ENGR	
				MAP CORRECTED BY	CHECKED BY	BES REVIEWER	$\ $
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NO.	DATE	DESCRIPTION	APPD.			PBOT REVIEWER	
		REVISIONS	<del></del>	FINAL MAP DATA		AM	

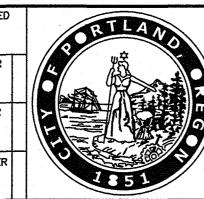

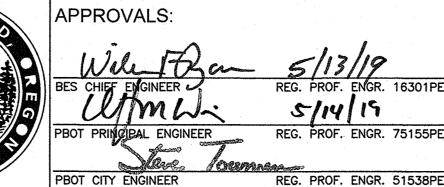

# 5/13/19 REG. PROF. ENGR. 16301PE

**BUREAU OF ENVIRONMENTAL SERVICES** NICK FISH

WILLIAM F. RYAN, P.E.

COMMISSIONER

**TRANSPORTATION** 


**BUREAU OF** 

CHLOE EUDALY CHIEF ENGINEER STEVE TOWNSEN, P.E.

COMMISSIONER CITY ENGINEER



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**EROSION CONTROL NOTES AND DETAILS** 

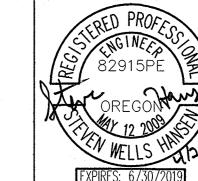PBOT JOB NO. TH0793 SHEET NO.

EP492

EC2 of 2